INLAND WETLANDS COMMISSION TUESDAY, November 10, 2020 ZOOM Meeting

- A) Call to Order & Roll Call
- B) Appointment of Alternates

Agenda Item C.a. Action on Minutes of Previous Meeting Minutes of October 13, 2020


Agenda Item D. Citizens Comments on Agenda Items

Agenda Item E.a) 1. Old Applications

WAA20009 Hallet T. Merrick, 0 Plum Road, Assessor's map 85, block 52, lot 12, construction of single family home, septic system and portion of home proposed in 100 foot upland review area, stamped received 4/13/2020, under review pending receipt of additional information.

Agenda Item E.a) 2.Old Applications

IWA20011 James Jasmine, 518 Brandy Hill Rd, Assessor's map 143, block 16, lot 37, after-the-fact application for partial demolition of retaining wall and construction of new retaining wall on Quaddick Reservoir, stamped received 5/6/2020, statutorily received 5/14/2020.

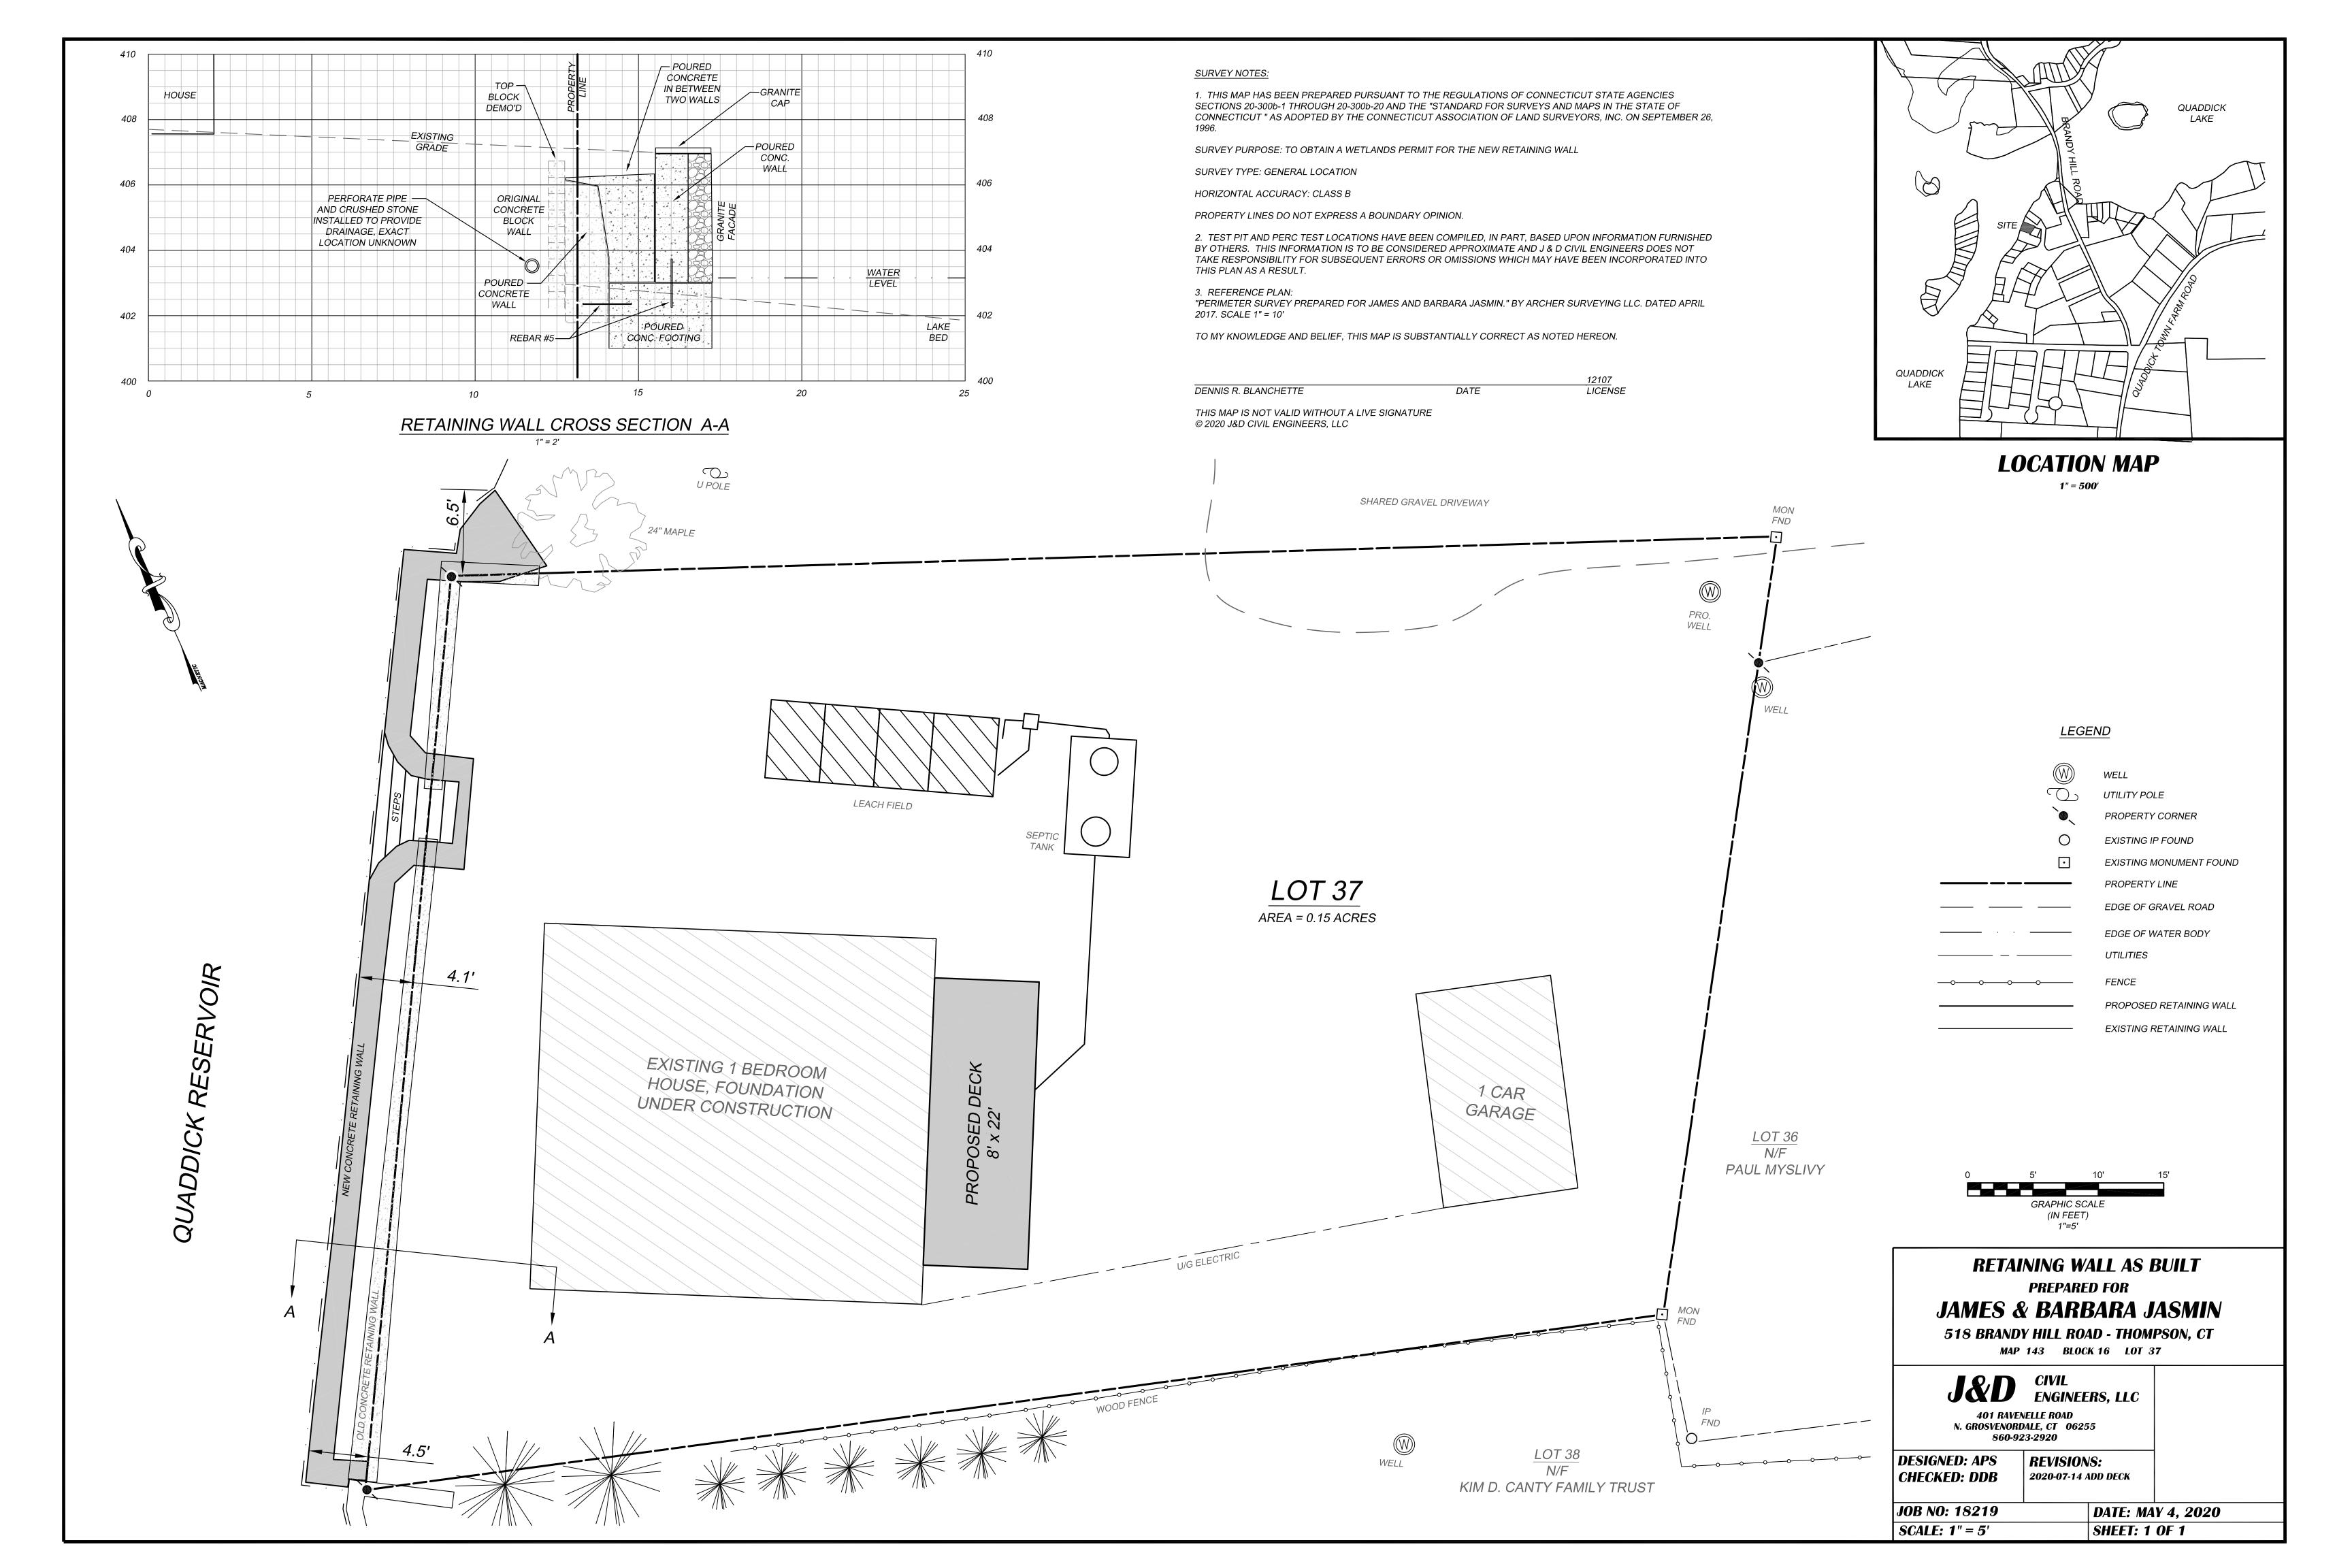

Jamie Boucher

2 Island View Drive Thompson, CT 06277

June 7, 2020

Town of Thompson Connecticut Inland Wetlands Commission 815 Riverside Drive P.O. Box 899 North Grosvenordale, CT. 06255

Attention: Marla Butts, Inland Wetlands Agent

I am the President of the Green Acres Association. Green Acres Association owns the common lot that is located directly adjacent to James & Barbara Jasmin's property. I have been made aware Mr. Jasmin did not involve the Inland Wetlands Commission before constructing a new retaining wall to replace the existing wall that was crumbling and unsafe. Also constructed was a separate smaller retaining wall that attended beyond the Jasmin's property line encroaching onto the common lot Boat launch area. After reviewing the smaller section of wall that encroached upon the Boat launch, I find that the wall was extremely well constructed and that it did not encroaching upon the useable areas of the Boat launch or its open boat storage areas. The wall was constructed to retain the steep bank that had been washed away over time by the waves. Lights was added along the Top of the wall to ad in night time navigation helping boaters to locate the Boat Launch more easily and safely after sunset.

Enclosing this small extension of the Jasmin's retaining wall has, at no cost to the Green Acres Association, improved the longevity, safety and appearance of the Green Acres Association's property. In general, all parties seem pleased with the improvements.

Sincerely

Jamie Boucher

President of the,

Green Acres Association

Phone # 81-1-753-0794



Town of Thompson Inland Wetlands Commission

815 Riverside Drive North Grosvenordale, CT 06255 860-923-1852 (Office) 860-923-9897 (Fax)

Memo

To: Thompson Inland Wetlands Commission

From: Marla Butts, Wetlands Agent

Date: November 9, 2020

Re: Recommendation on Application IWA20011, James Jasmine, 518

Brandy Hill Road

Regarding those portions of the retaining wall that exist on the land not owned by James Jasmine, I have not received any response to my repeated requests for a position on the wall from the Connecticut Department of Energy and Environmental Protection. Additionally, on June 9, 2020 I received an email from Mr. Jasmine containing a scan of a letter from a Jamie Boucher, as President of the Green Acres Association, who claimed the Association owned the land adjacent to the Jasmin property upon which a small portion of the unauthorized wall was constructed and had no objection to the wall as constructed. Unfortunately, I have been unable to verify that the Green Acres Association has title to the property in question.

Consequently, I recommend the Commission render a decision on the application as follows:

Move to conditionally approve Application IWA20011by James Jasmine for regulated activities as shown in plans entitled "Retaining Wall As Built Prepared for James & Barbara Jasmin, 518 Brandy Hill Road – Thompson, CT." prepared by J & J Civil Engineers, LLC dated May 4, 2020 revised 2020-07-14 for all activities located on his property and to deny any portion of the wall and associated fill that does not exist on Mr. Jasmin's property on the basis that Mr. Jasmin has failed to show that he has any rights to maintain those portions of the wall and associated fill.

Further I recommend the Commission take no further action in this matter as long as no new regulated activities occur as a result of Mr. Jasmin's activities.

File: Memo WA Decision Recommendation Application IWA20011 Jasmine.doc



Agenda Item E.a) 3. Old Applications

WAA20031, Madison Avenue Investments, LLC, 0 Madison Ave. (Assessor's map 103, block 31, lot 6K, subdivision lot 11), driveway and grading for new single family home, stamped received 8/3/2020, under review.

Agenda Item E.a) 4. Old Applications

WAA20033, Madison Avenue Investments, LLC, 0 Madison Ave. (Assessor's map 103, block 31, lot 6R, subdivision lot 18), septic system for new single family home, stamped received 8/12/2020, under review.

Agenda Item E.a) 5. Old Applications


WAA20038, Joseph Kelly, 0 Lowell Davis Rd., (Assessor's map 120, block 30, lot 3A), grading and well in 100-foot upland review area for a new single family home, stamped received 10/5/2020, approved 10/22/2020, legal notice published 11/6/2020, appeal period ends 11/21/2020.


Agenda Item E.a) 6. Old Applications


WAA20040, Laura Hauser, 31 Center St. (Assessor's map 116, block 30, lot 3A), reconstruction of a single family home in 100-foot upland review area for Little Pond, stamped received by the Town Clerk 9/18/2020 and 10/5/ 2020 by the Wetlands Office, under review.

Agenda Item E.a) 7. Old Applications

IWA20041, Jerry T. Mileno, 523 & 521 Brandy Hill Rd. (Assessor's map 143, block 17, lots 4 &3), demolish and reconstruct retaining walls, reconstruction of a single family home in 100-foot upland review area for Little Pond, stamped received 10/7/2020, revised plans received 10/9/2020.

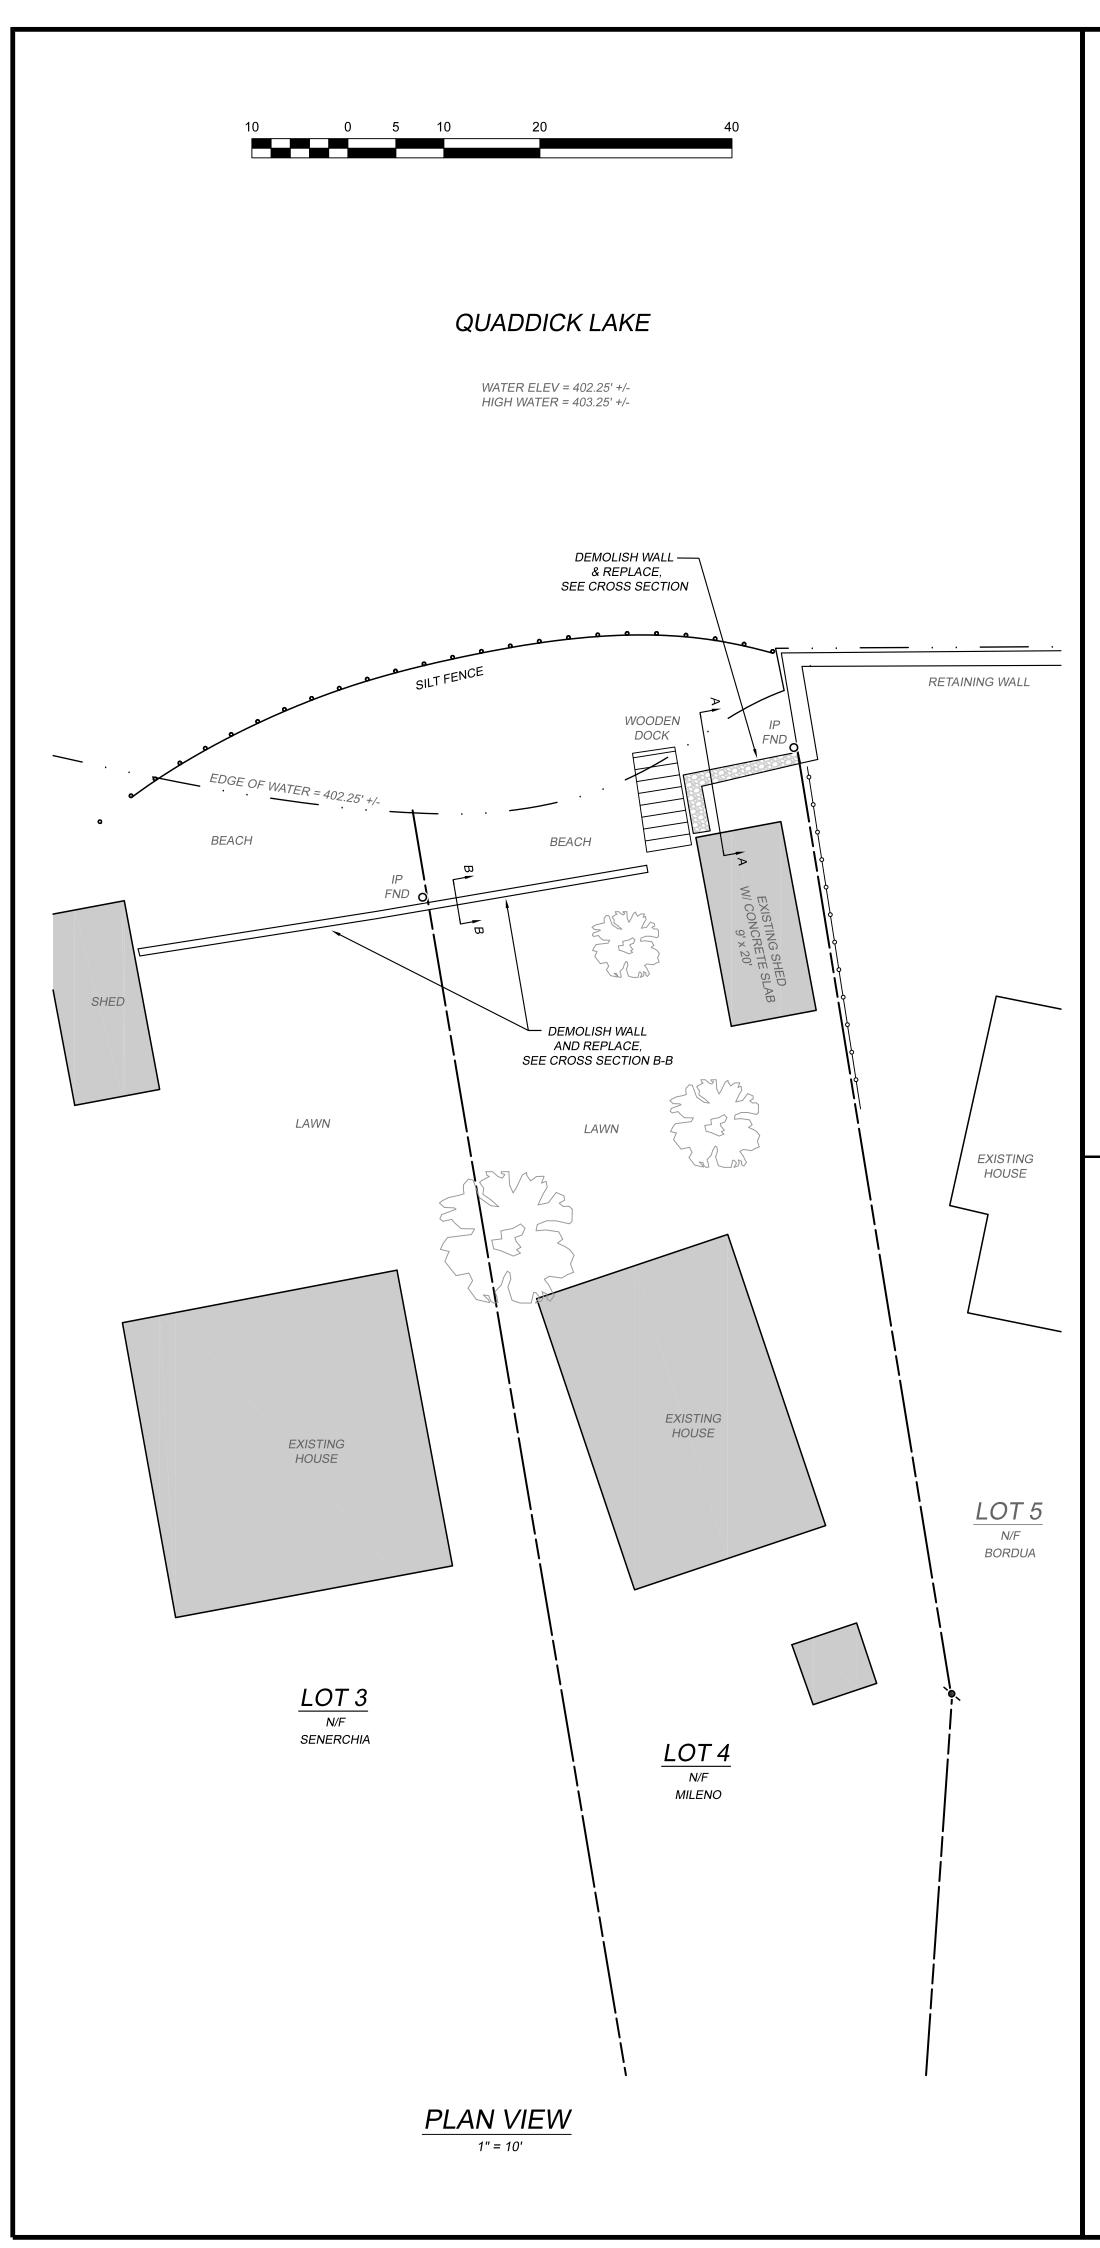

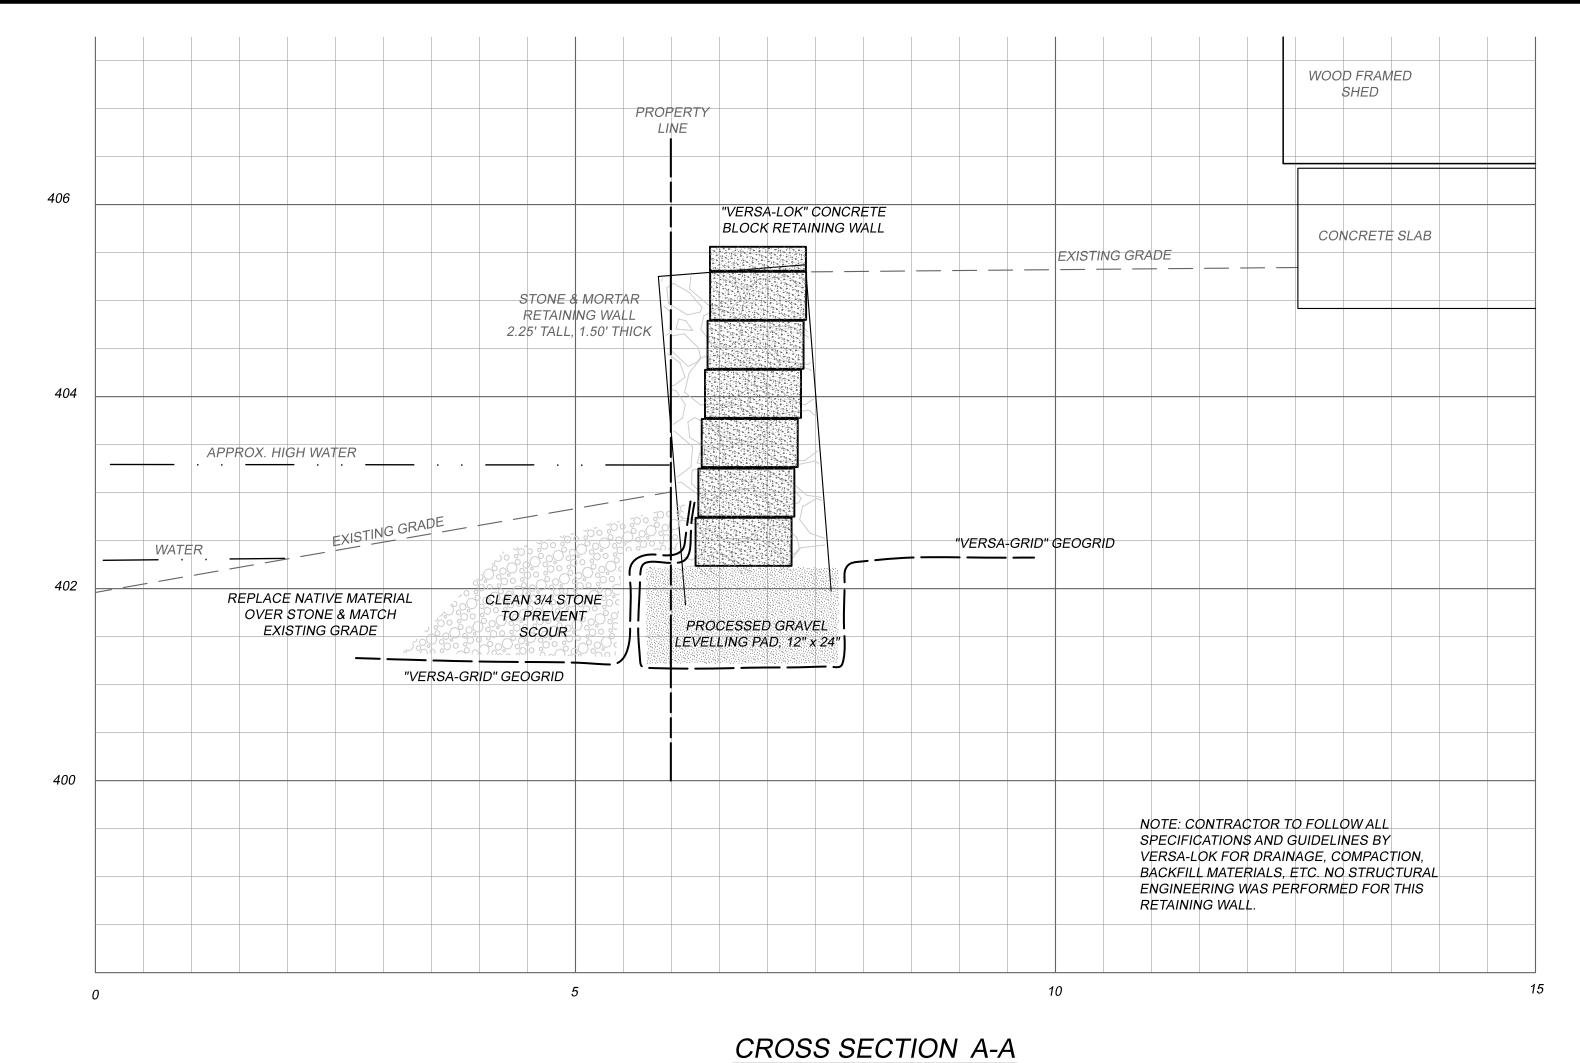

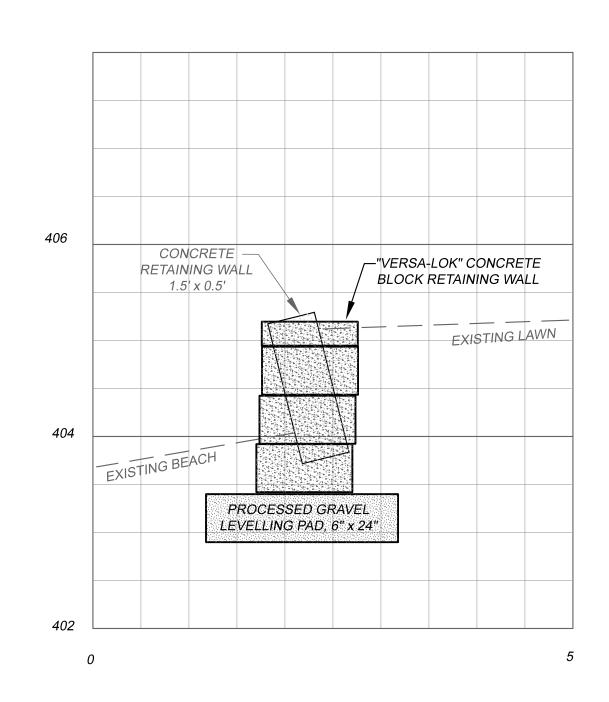

CROSS SECTION B-B

GENERAL CONSTRUCTION NOTES


- 1. ALL PROPOSED DEMOLITION OR CONSTRUCTION SHALL TAKE PLACE DURING THE
- WINTER DRAW DOWN PERIOD, WHEN THE WATER LEVEL IS SIGNIFICANTLY LOWER. 2. NO MACHINERY OR EQUIPMENT SHALL BE PLACED WITHIN THE WATER.
- 3. NO EXCAVATION OR EARTHWORK SHALL OCCUR WITHIN THE WATER.
- 4. EROSION CONTROL DEVICES SHALL BE INSTALLED PRIOR TO ANY WORK. 5. THE RETAINING WALL TO BE REPLACED IS APPROXIMATELY 6' BY 12'.
- 6. THE CONTRACTOR SHALL FOLLOW ALL SPECIFICATIONS AND INSTRUCTIONS PROVIDED BY THE CONCRETE BLOCK MANUFACTURER OR SUPPLIER.
- 7. THE CONTRACTOR SHALL TAKE MEASURES TO AVOID OR PREVENT ANY DAMAGE TO
- THE ADJACENT RETAINING WALL OWNED BY THE NEIGHBOR BORDUA.
- 8. THE CONTRACTOR SHALL AVOID ANY EXCAVATION THAT WOULD DISTURB THE NEARBY CONCRETE SLAB FOUNDATION.
- 9. THE CONTRACTOR SHALL CONSULT WITH THE ENGINEER PRIOR TO ANY SUBSTITUTIONS OR ALTERATIONS.

CONSTRUCTION SEQUENCE

- 1. INSTALL EROSION CONTROL DEVICES IN ACCORDANCE WITH THE SITE PLAN.
- 2. EXCAVATE FILL MATERIAL AT FOOTING AND BEHIND WALL. 3. DEMOLISH RETAINING WALL AND HAUL OFF SITE.
- 4. EXCAVATE NATIVE MATERIAL AS NECESSARY, COMPACT, AND INSTALL GEOGRID.
- 5. INSTALL AND COMPACT BASE LEVELING PAD. 6. ROLL UP ORIGINAL GEOGRID, AND INSTALL SECOND GEOGRID.
- 7. INSTALL FIRST TWO COURSES OF CONCRETE BLOCKS.
- 8. INSTALL CRUSHED STONE OVER GEOGRID, LEVELLING PAD AND FIRST LAYER OF
- 9. COMPLETE RETAINING WALL INSTALLATION, FOLLOWING ALL SPECIFICATIONS AND INSTRUCTIONS PROVIDED BY THE CONCRETE BLOCK MANUFACTURER OR SUPPLIER.

EROSION AND SEDIMENT CONTROL NOTES

- RETAINING WALL, AND THE CONSTRUCTION OF A CONCRETE BLOCK RETAINING WALL IN THE SAME LOCATION.
- 2. EROSION CONTROL DEVICES SHALL BE INSTALLED ACCORDING TO THE SITE PLAN, PRIOR TO ANY EARTHWORK OR DEMOLITION.
- 4. THE CONTRACTOR SHALL INSTALL ADDITIONAL EROSION CONTROL DEVICES AS NECESSARY TO PREVENT ANY SEDIMENT FROM ENTERING THE WATER.
- 6. FINAL GRADE AND STABILIZE ALL DISTURBANCES AS SOON AS POSSIBLE.

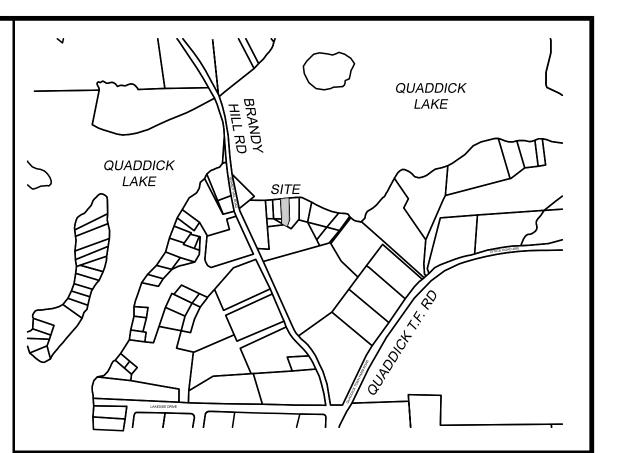

LOCATION MAP

SURVEY NOTES:

1. THIS MAP HAS BEEN PREPARED PURSUANT TO THE REGULATIONS OF CONNECTICUT STATE AGENCIES SECTIONS 20-300b-1 THROUGH 20-300b-20 AND THE "STANDARD FOR SURVEYS AND MAPS IN THE STATE OF CONNECTICUT "AS ADOPTED BY THE CONNECTICUT ASSOCIATION OF LAND SURVEYORS, INC. ON SEPTEMBER 26, 1996.

THE SURVEY TYPE IS TOPOGRAPHIC, PERFORMED ON OCTOBER 2, 2020, AND IS INTENDED TO BE USED FOR THE DESIGN OF A RETAINING WALL.

VERTICAL ACCURACY: CLASS T2 (NAVD88 DATUM) HORIZONTAL ACCURACY: CLASS B (NAD83 DATUM) FOR THE TALLER RETAINING WALL, CLASS D FOR ALL ELSE.

PROPERTY LINES DO NOT EXPRESS A BOUNDARY OPINION.

2. REFERENCE PLAN: "SUBDIVISION OF LAND OWNED BY CLAIRE L. GREEN, BRANDY HILL ROAD THOMPSON CT." BY ALBERT FIZTBACK, LLS. DATED MAY 19, 1988. ON FILE AS MAP 1060-1.


TO MY KNOWLEDGE AND BELIEF, THIS MAP IS SUBSTANTIALLY CORRECT AS NOTED HEREON.

DENNIS R. BLANCHETTE

LICENSE NUMBER


THIS MAP IS NOT VALID WITHOUT A LIVE SIGNATURE © 2020 J&D CIVIL ENGINEERS, LLC

LEGEND

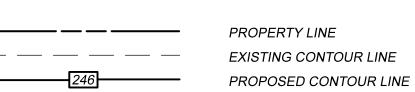

EDGE OF WATER

EROSION CONTROL DEVICES

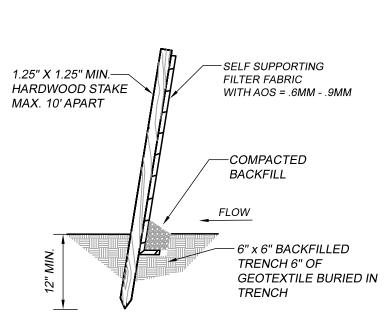

SILT FENCE INSTALLATION NOT TO SCALE

RETAINING WALL PLAN PREPARED FOR **JERRY & ROBERT MILENO**

NATIVE SOIL

523 BRANDY HILL ROAD - THOMPSON, CT MAP 143 BLOCK 17 LOT 3 & 4



DESIGNED: DDB CHECKED: DRB

SCALE: AS NOTED

REVISIONS: 2020-10-09 2ND CROSS SECTION

JOB NO: 20232 **DATE: OCTOBER 7, 2020**

SHEET: 1 OF 1

1. THE PROPOSED WORK SHALL CONSIST OF THE DEMOLITION OF AN EXISTING

3. THE CONTRACTOR SHALL ADEQUATELY INSPECT AND MAINTAIN ALL EROSION

5. DISTURBED AREAS SHALL BE KEPT TO A MINIMUM.

79 Elm Street • Hartford, CT 06106-5127

www.ct.gov/deep

Affirmative Action/Equal Opportunity Employer

October 15, 2020

Daniel Blanchette J&D Civil Engineers LLC 401 Ravenlle Rd North Grosvernordale CT 06255 daniel@jdcivilengineers.com

Project: Demolish existing stone retaining wall, replace with new concrete block retaining wall, 523 Brandy

Hill Rd, Thompson, CT

NDDB Determination No.: 202012141

Dear Daniel Blanchette,

I have reviewed Natural Diversity Database (NDDB) maps and files regarding the area of work provided for the proposed demolition of existing retaining wall and replacement with new concrete block retaining wall at 523 Brandy Hill Rod on Quaddick Reservoir in Thompson, Connecticut. I do not anticipate negative impacts to State-listed species (RCSA Sec. 26-306) resulting from your proposed activity at the site based upon the information contained within the NDDB. The result of this review does not preclude the possibility that listed species may be encountered on site and that additional action may be necessary to remain in compliance with certain state permits. This determination is good for two years. Please re-submit a new NDDB Request for Review if the scope of work changes or if work has not begun on this project by October 13, 2022.

Natural Diversity Data Base information includes all information regarding critical biological resources available to us at the time of the request. This information is a compilation of data collected over the years by the Department of Energy and Environmental Protection's Natural History Survey, cooperating units of DEEP, landowners, private conservation groups and the scientific community. This information is not necessarily the result of comprehensive or site-specific field investigations. Consultations with the NDDB should not be substitutes for on-site surveys necessary for a thorough environmental impact assessment. Current research projects and new contributors continue to identify additional populations of species and locations of habitats of concern, as well as, enhance existing data. Such new information is incorporated into the database as it becomes available.

Please contact me if you have further questions at (860) 424-3378, or karen.zyko@ct.gov. Thank you for consulting the Natural Diversity Database.

Sincerely,

Karen Zyko

Haus ffr


Environmental Analyst





Agenda Item E.b) 1.New Applications

WAA20043, Gary Rawson, 0 Logee Rd. (Assessor's map 141, block 17, lot E), construction of a new single family home in the 100-foot upland review area for Quaddick Reservoir, stamped received 10/29/ 2020, under review.

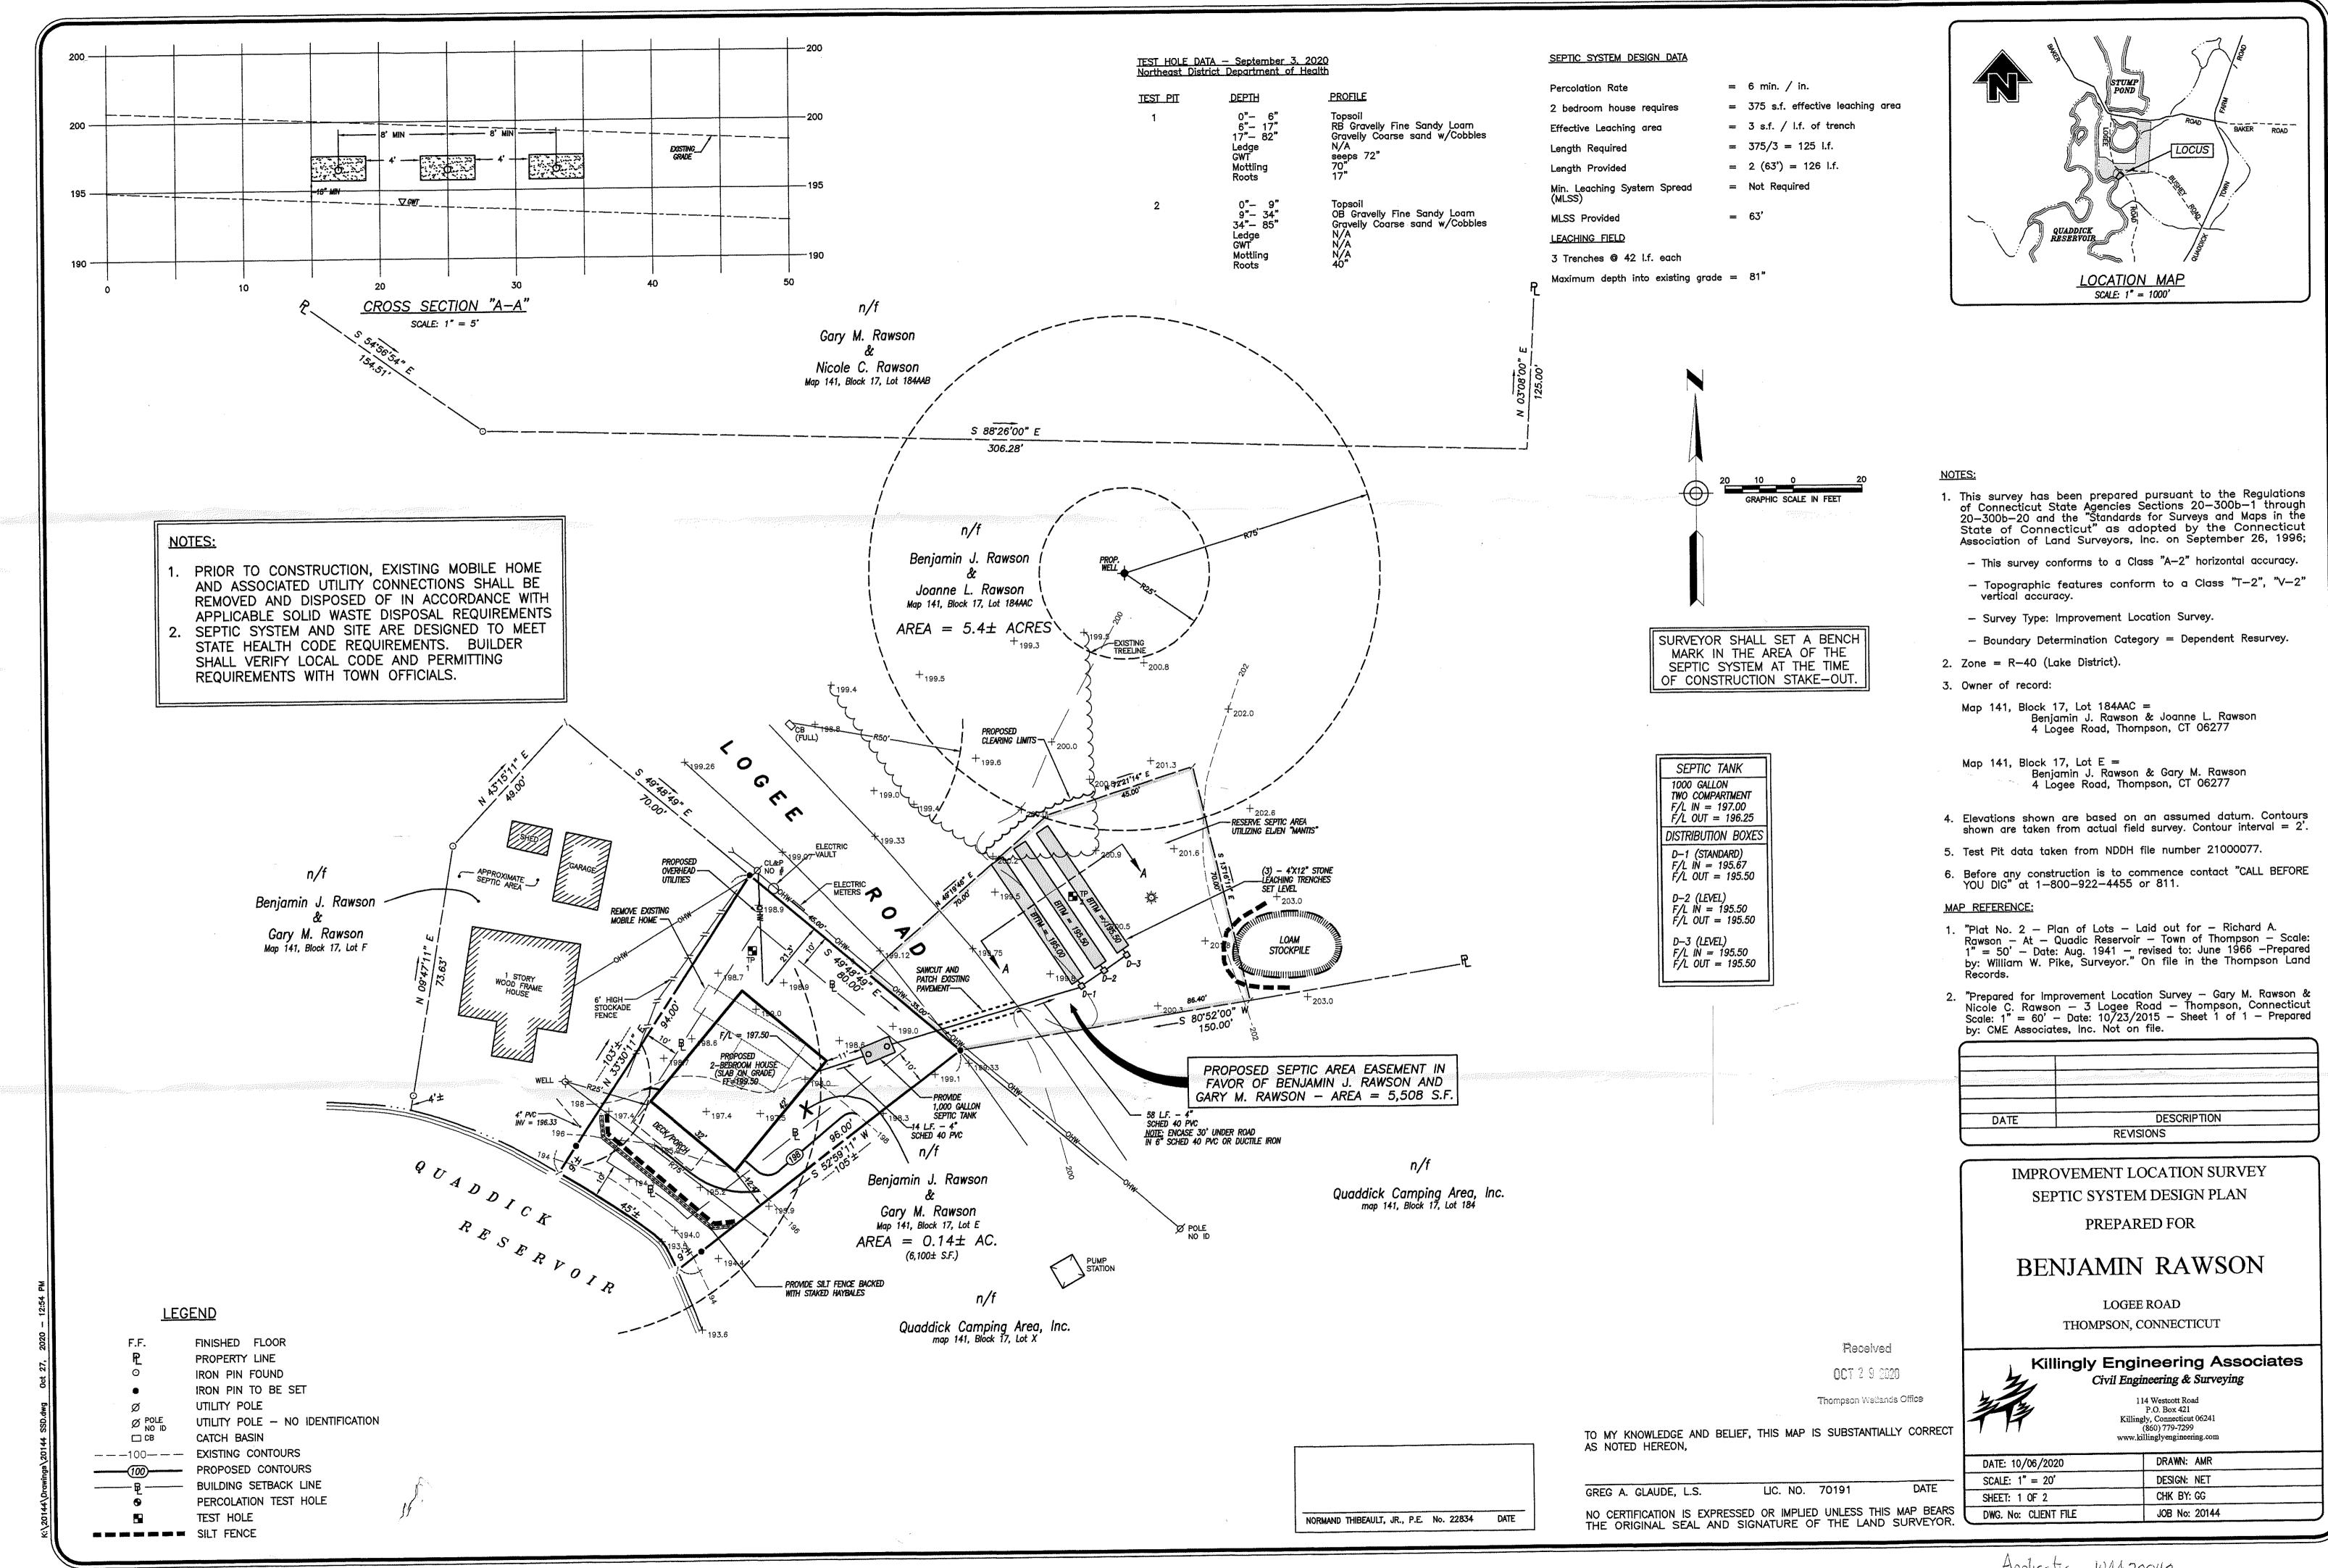

Agenda Item E.b) 2. New Applications

IWA20044, Town of Thompson, W. Thompson Rd (Assessor's maps 48 & 50, blocks 104 & 103, respectively, no lot #), replace existing culver carrying Wheaton Brook under W. Thompson Rd, stamped received 11/2/2020, to be received by statute 11/10/2020.

WHEATON BROOK CULVERT REPLACEMENT PLANS


WEST THOMPSON ROAD - THOMPSON, CT

PREPARED FOR TOWN OF THOMPSON

DATE: NOVEMBER 4, 2020 JOB NO: 18189

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- 1. COVER
- 2. EXISTING CONDITIONS PLAN
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- 4. ROADWAY PROFILE
- 5. ROADWAY CROSS SECTIONS
- 6. CULVERT PLAN & SECTIONS
- 7. CULVERT DETAILS
- 8. EROSION & SEDIMENTATION CONTROL
- 9. ROAD CLOSURE SIGN PLAN
- 10. GUIDE RAIL (CT DOT SHEET HW-910_02)
- 11. GUIDE RAIL (CT DOT SHEET HW-910_05)
- 12. GUIDE RAIL END ANCHORAGES (CT DOT SHEET HW-911_01)
- 13. CONSTRUCTION SIGNS (CT DOT SHEET TR-1220_01)
- 14. CONSTRUCTION SIGN SUPPORTS (CT DOT SHEET TR-1220-02)

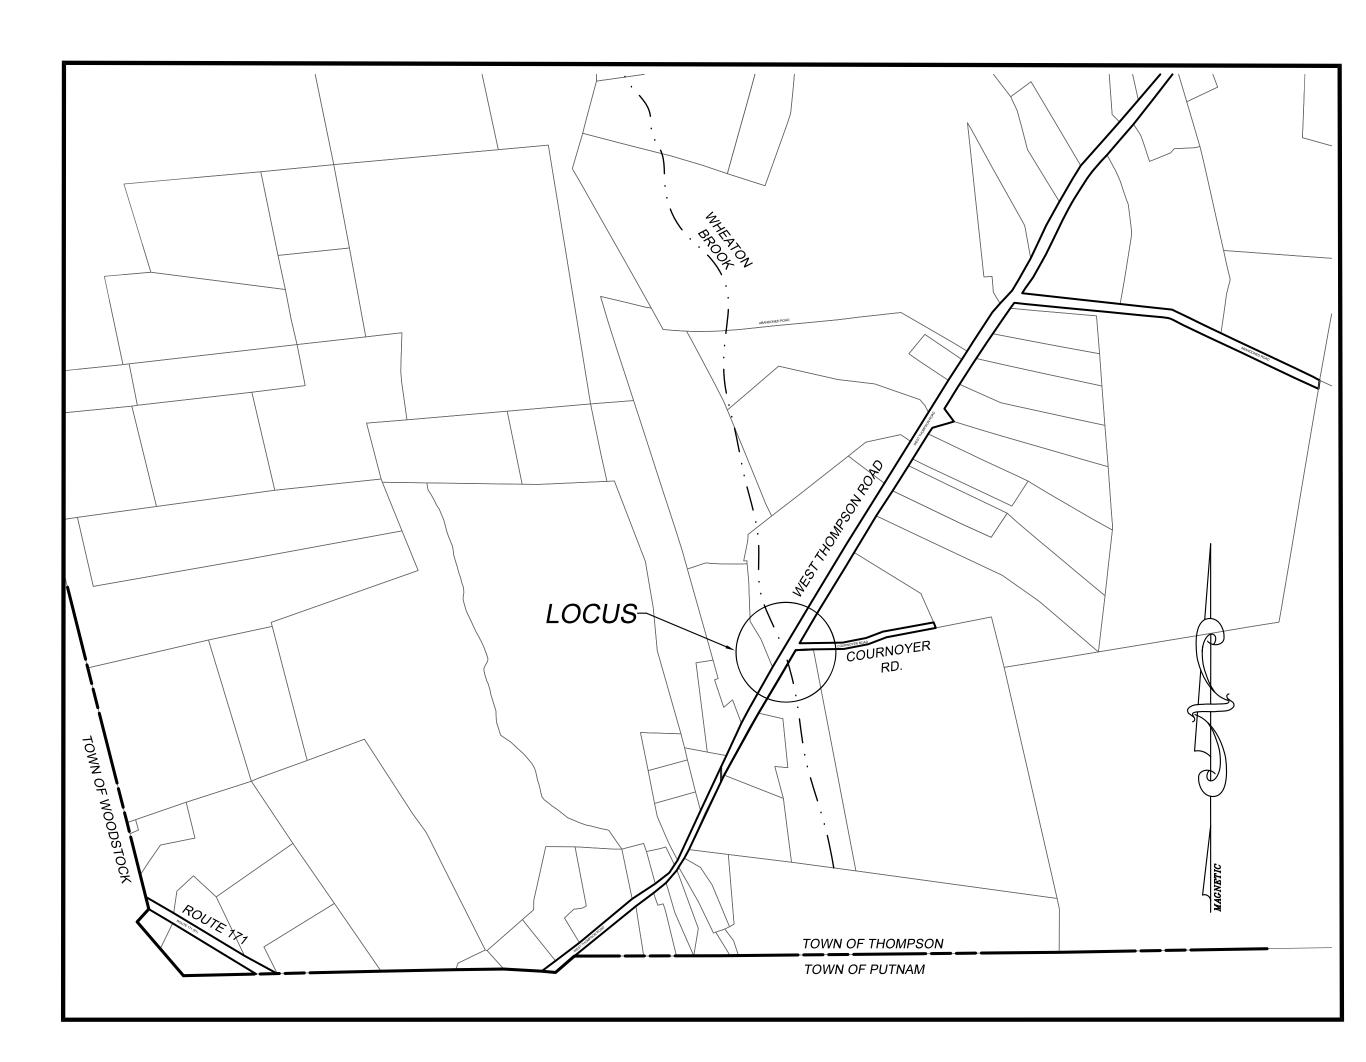

J&D CIVIL ENGINEERS, LLC

401 RAVENELLE ROAD

N. GROSVENORDALE, CT 06255

860-923-2920

WWW.JDCIVILENGINEERS.COM


LOCATION MAP


1" = **500**'


APPROVED
NLAND WETLANDS COMMISSION

CHAIRMAN

DATE

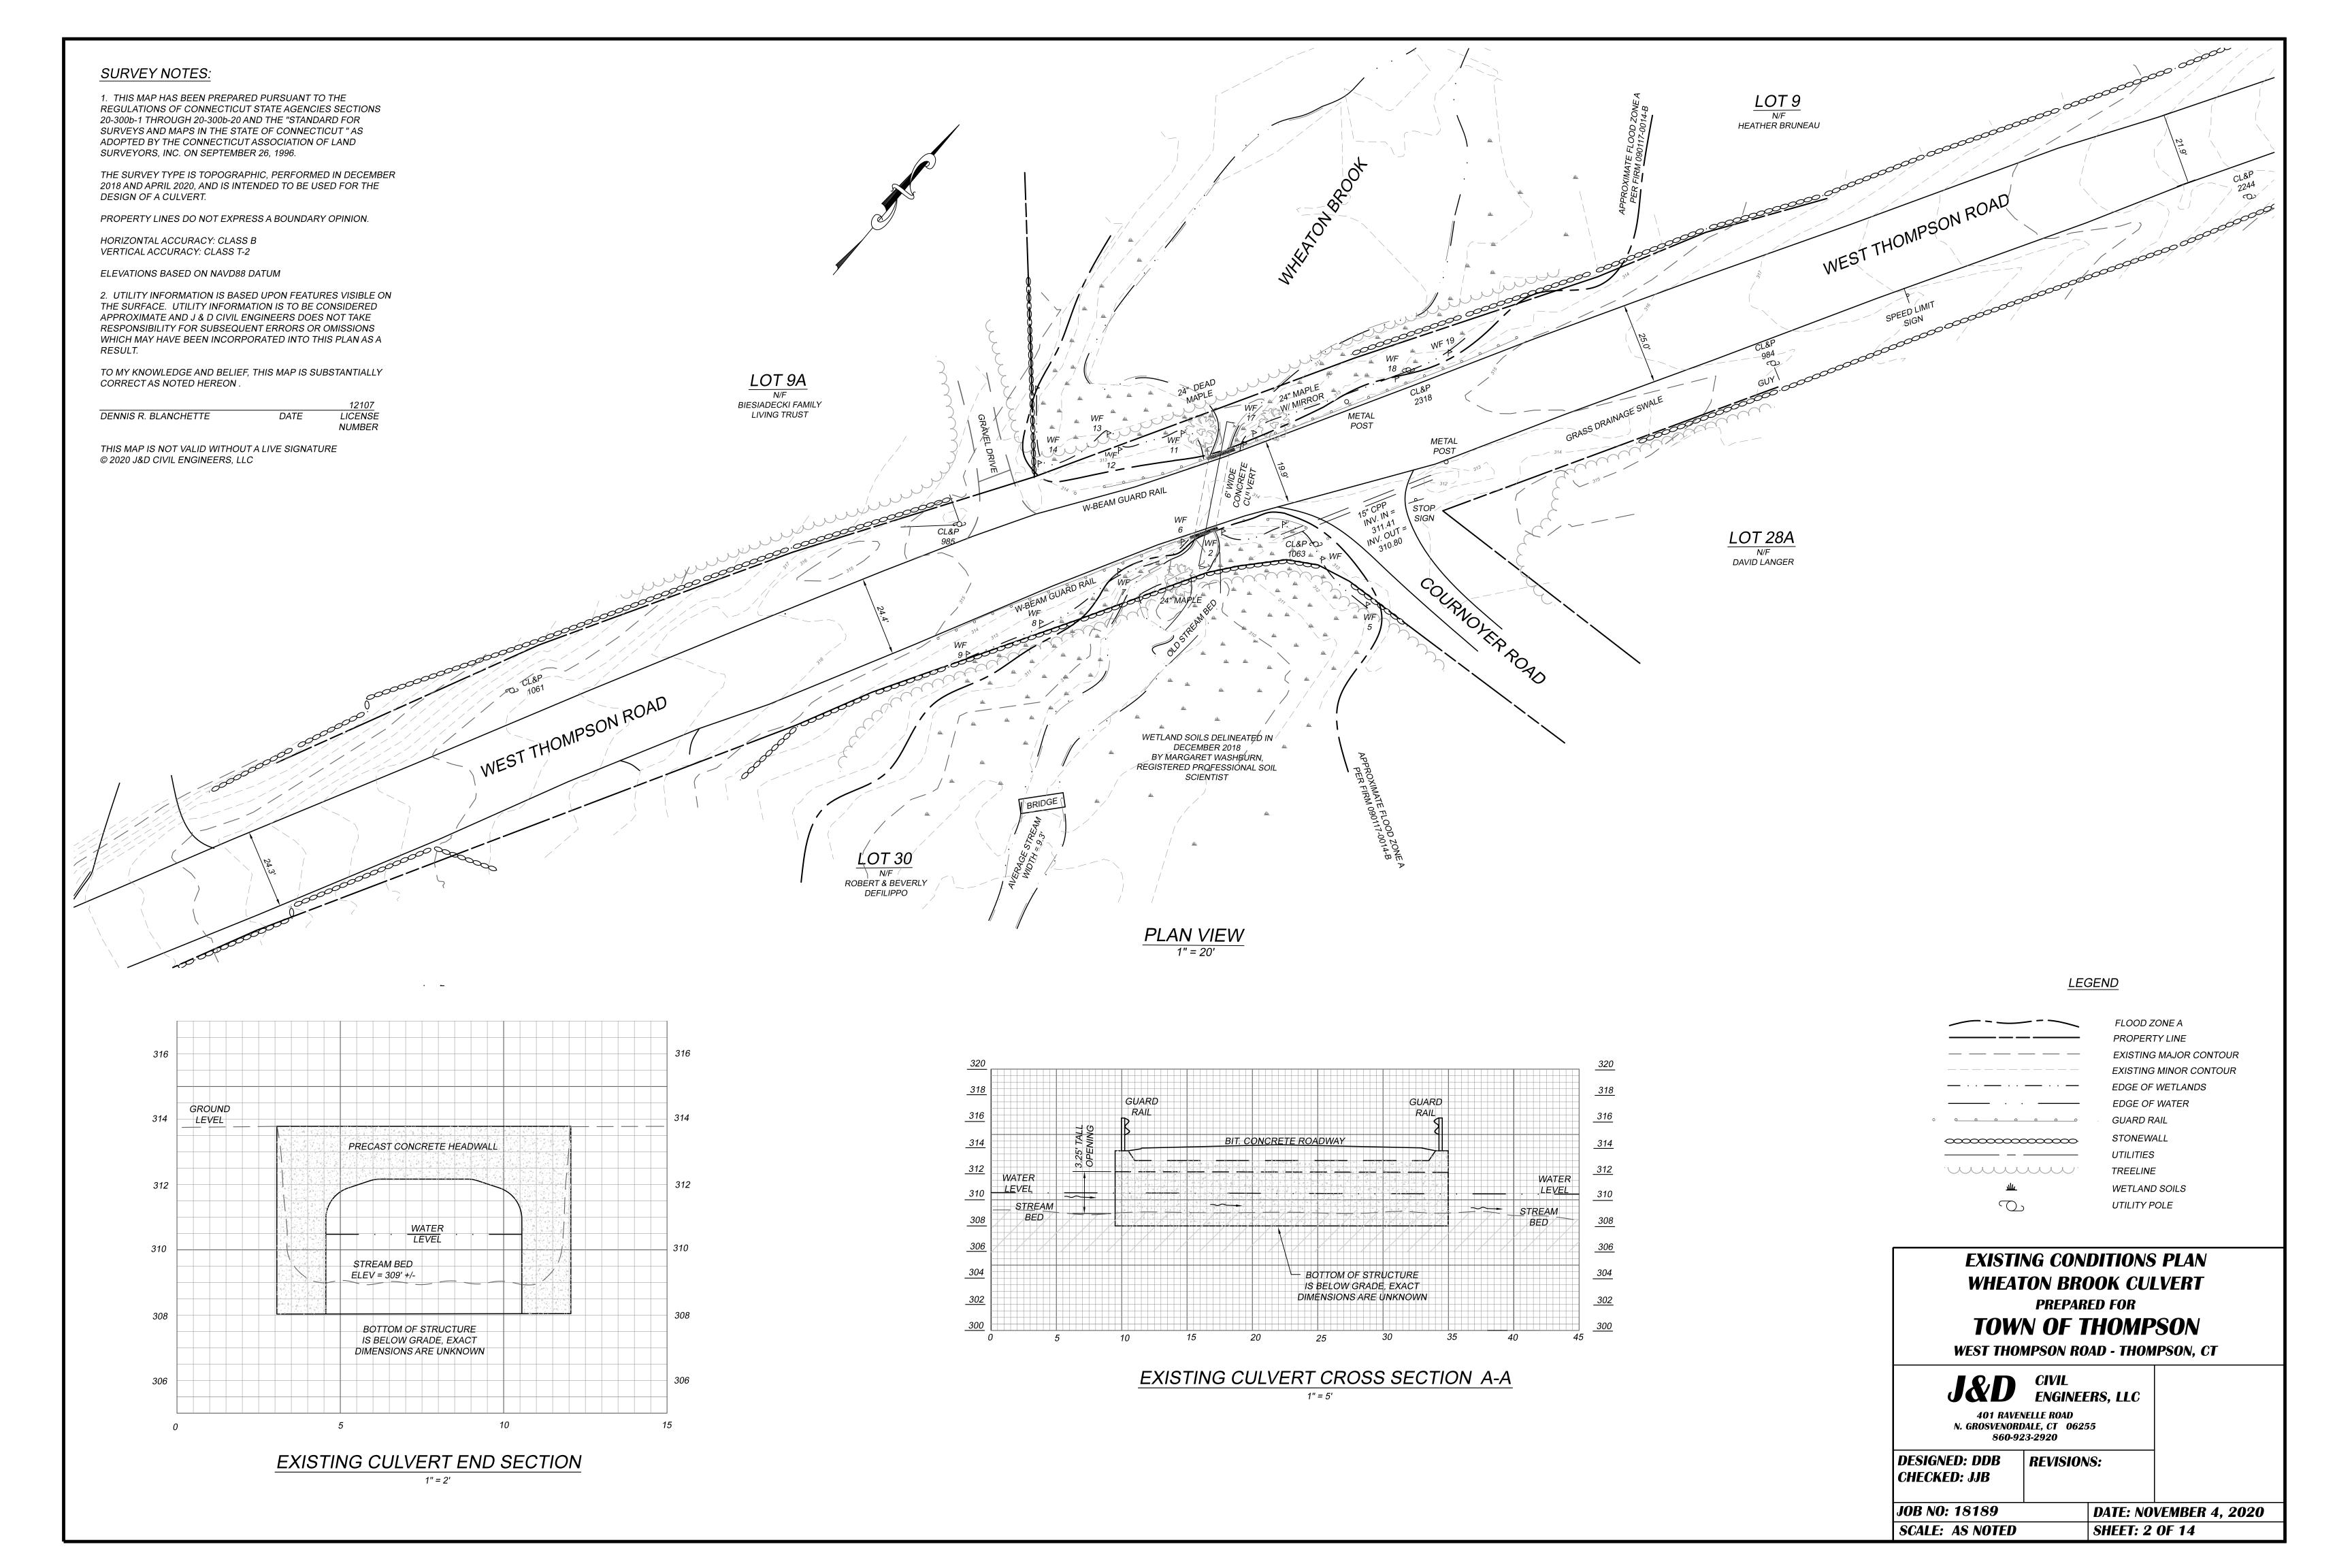

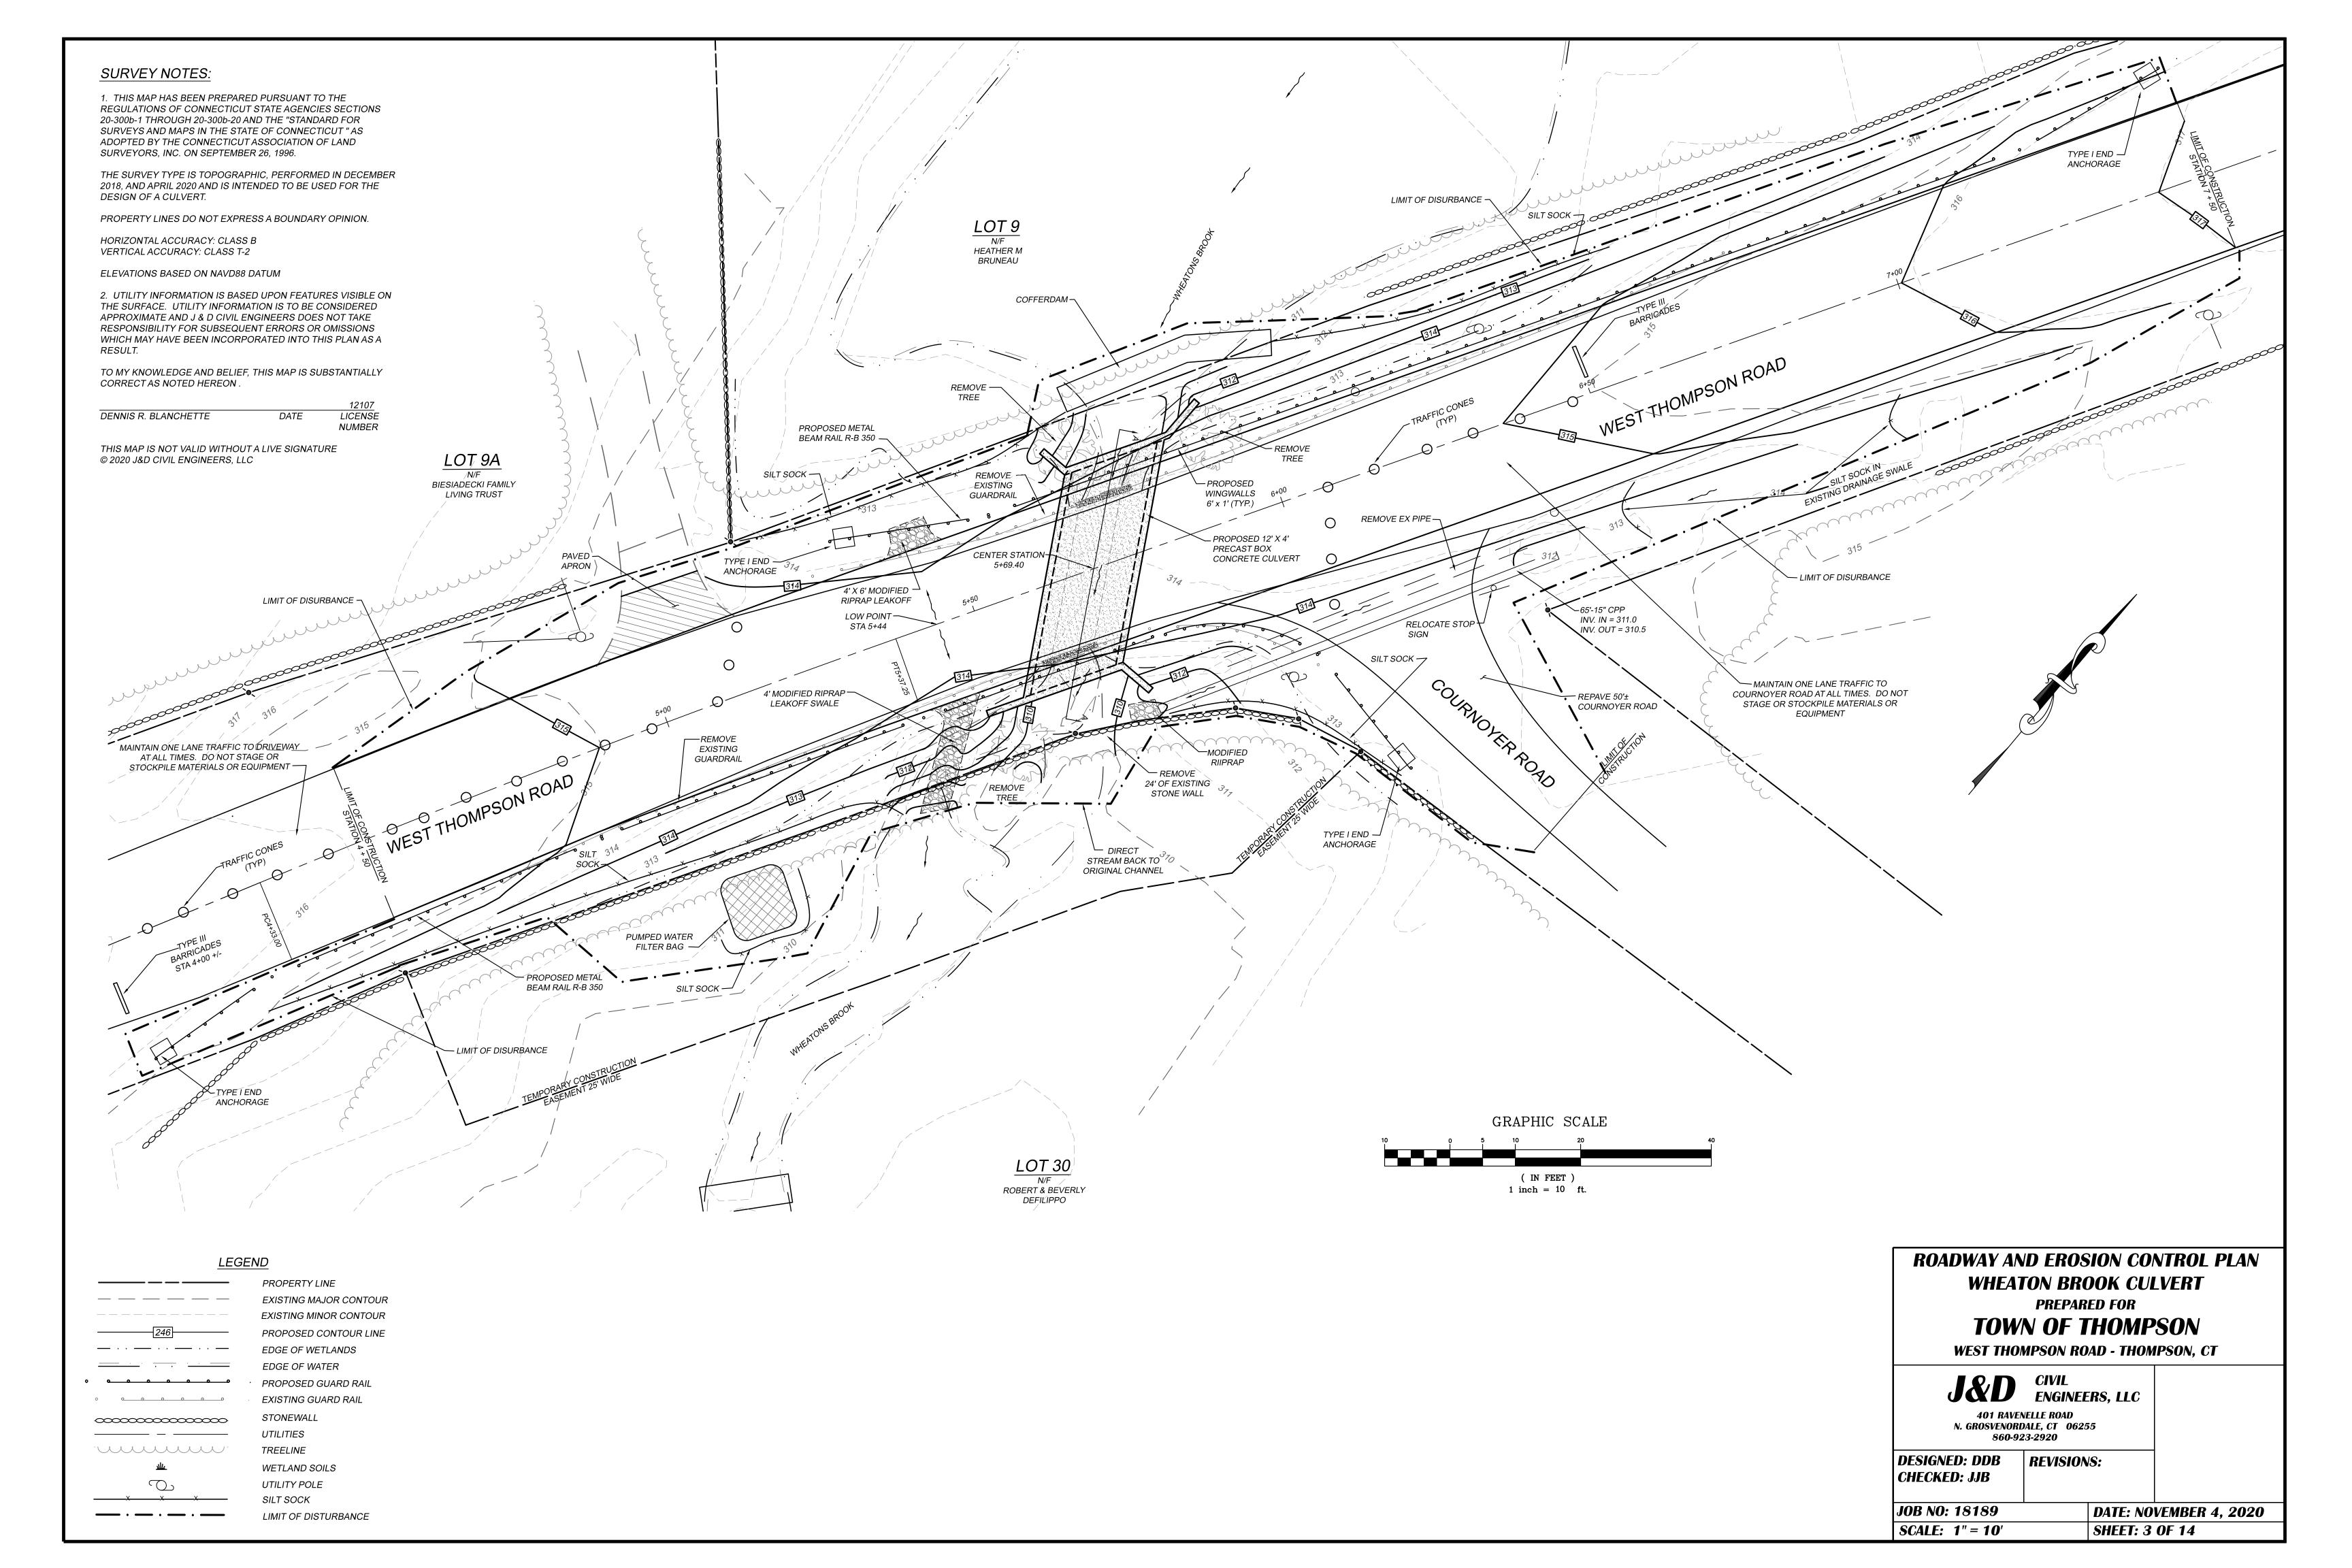

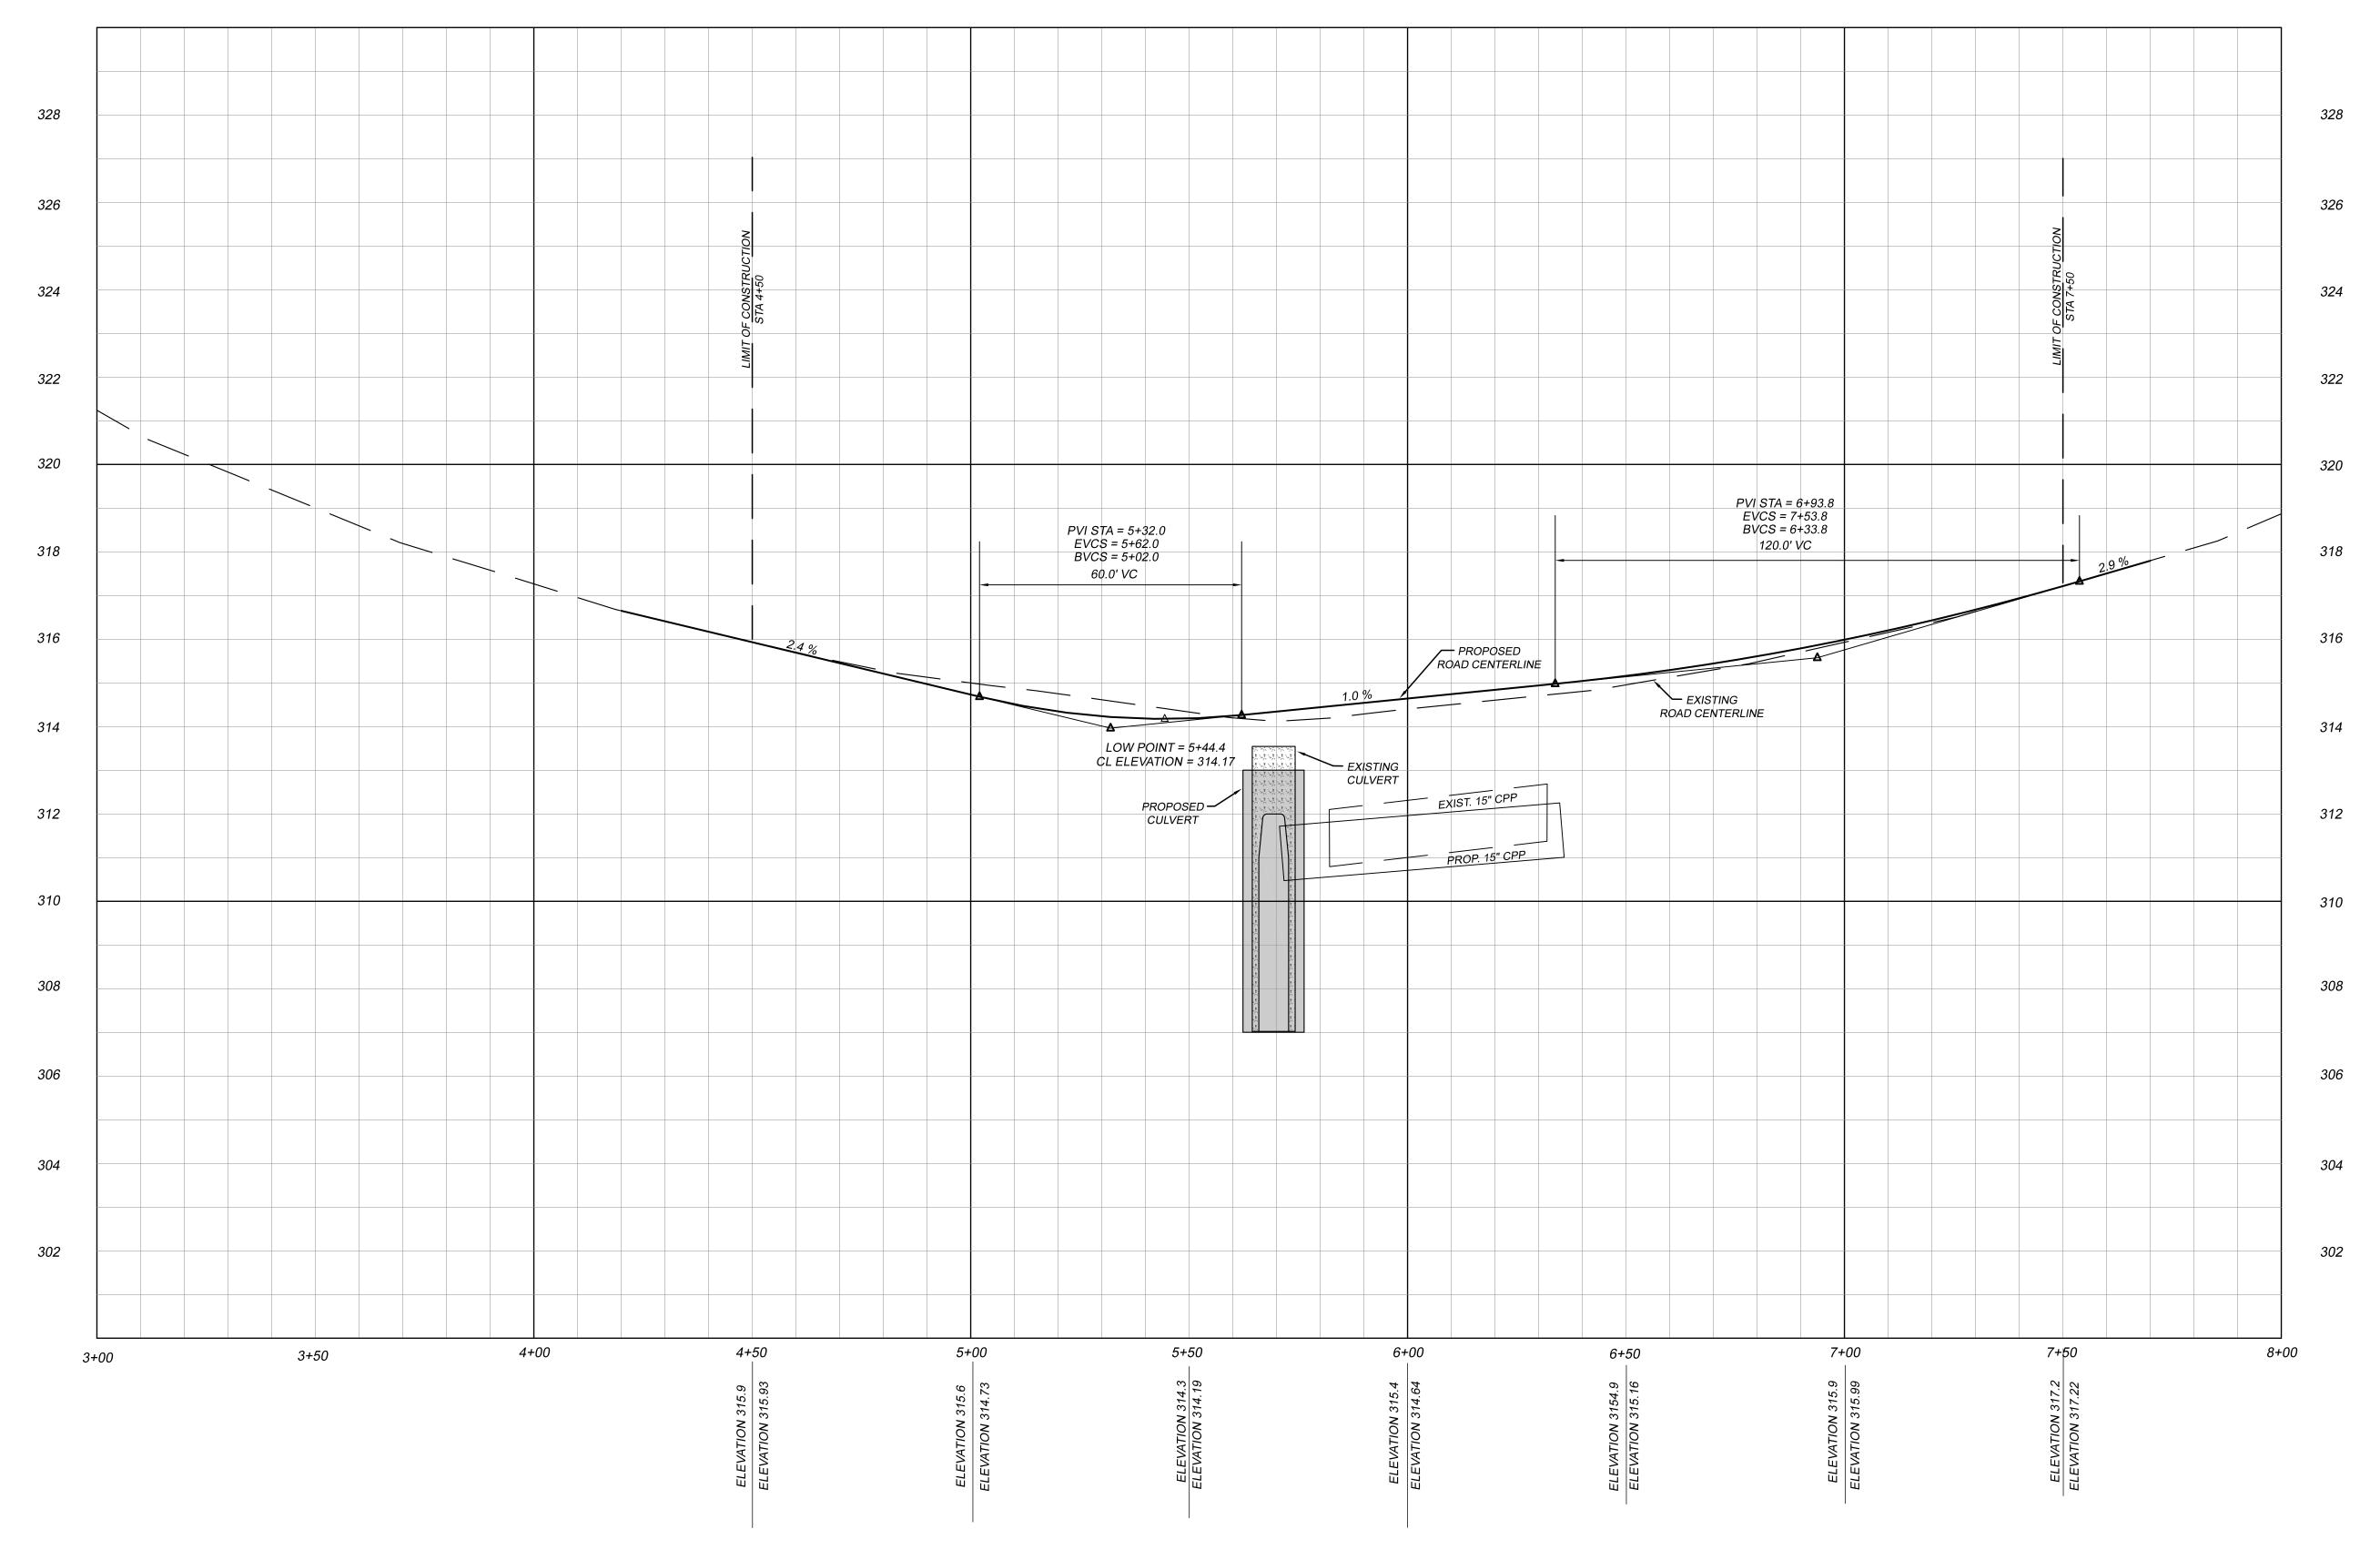

ROAD PROFILE HORIZONTAL SCALE: 1" = 20' VERTICAL SCALE: 1" = 2'

ROADWAY PROFILE WHEATON BROOK CULVERT PREPARED FOR TOWN OF THOMPSON

WEST THOMPSON ROAD - THOMPSON, CT



401 RAVENELLE ROAD N. GROSVENORDALE, CT 06255 860-923-2920


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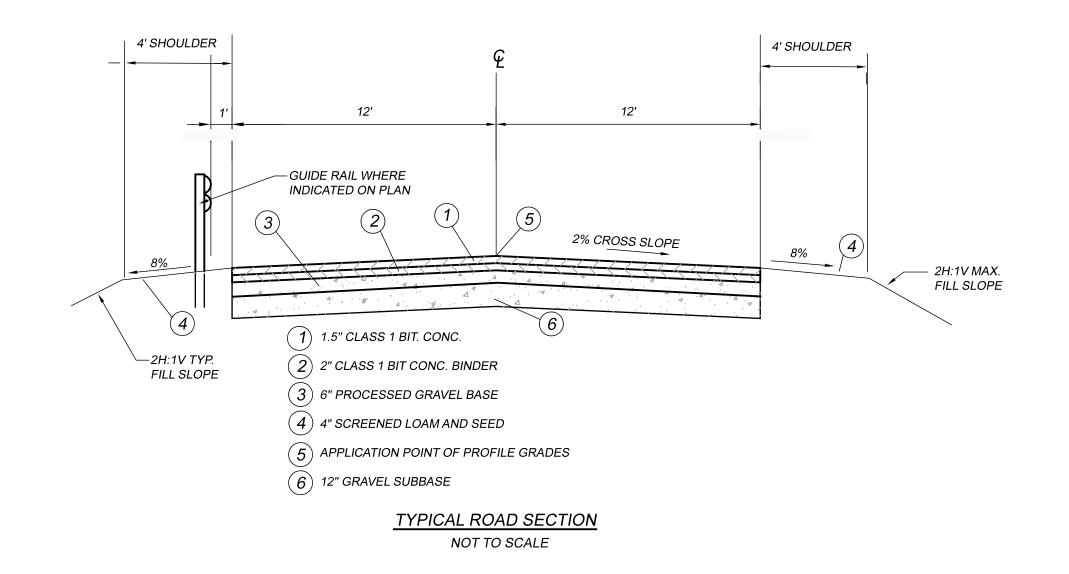
REVISIONS:


CHECKED: JJB

JOB NO: 18189 DATE: NOVEMBER 4, 2020

SHEET: 4 OF 14 SCALE: AS NOTED



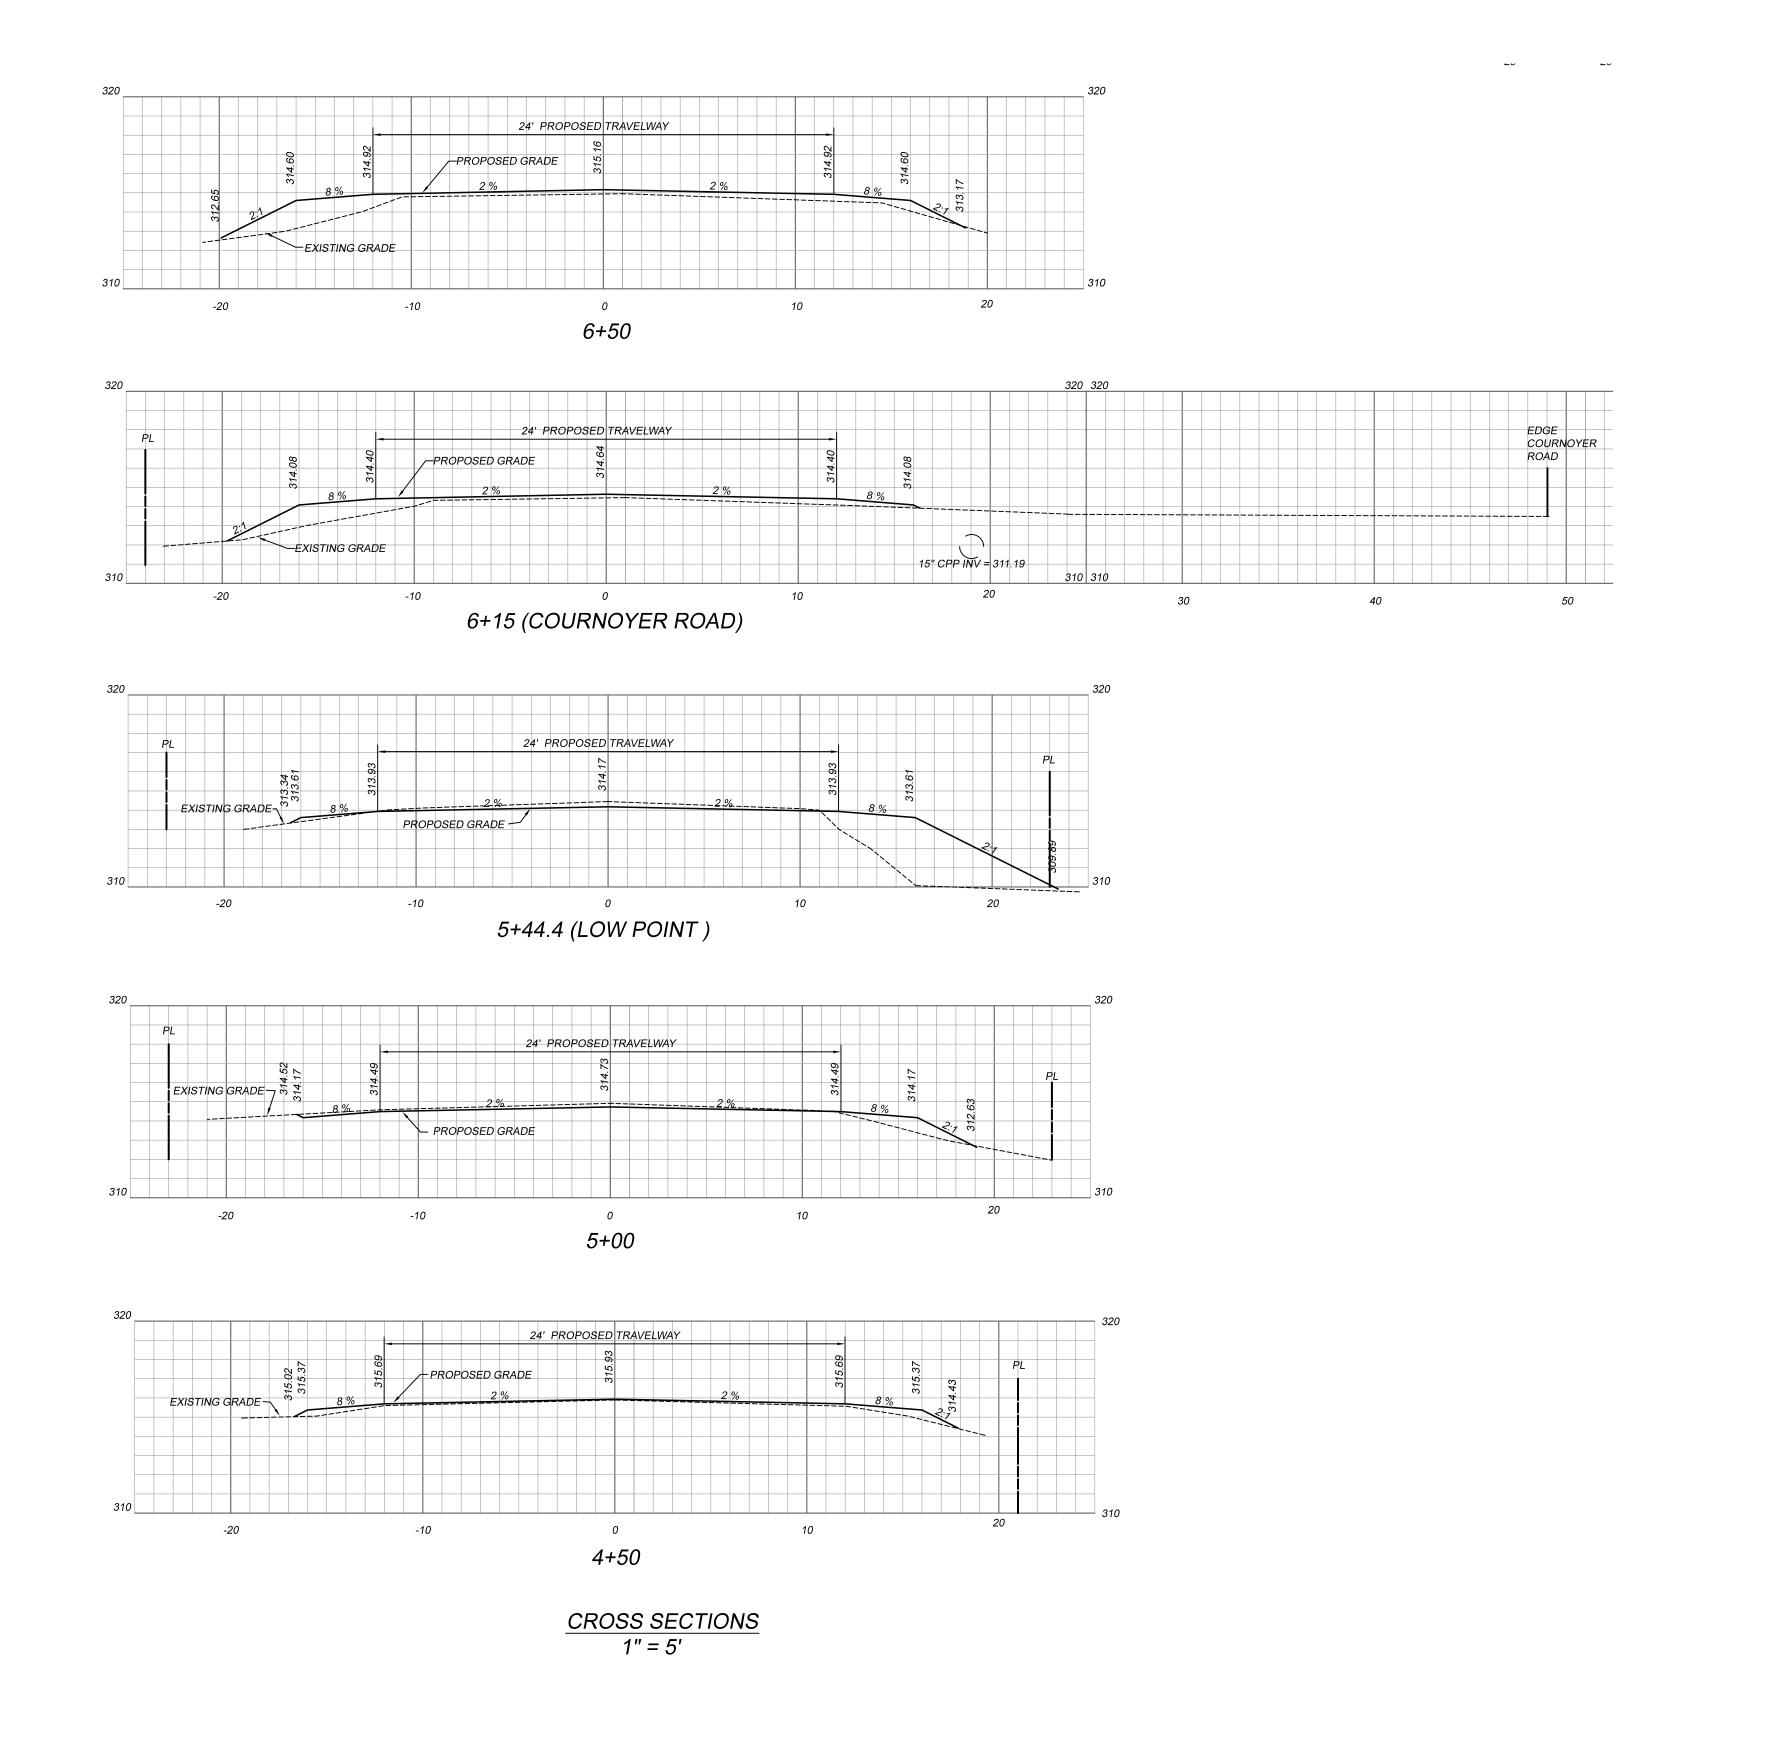

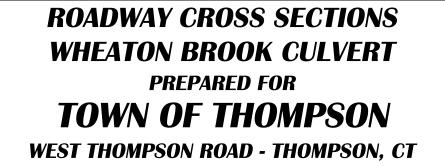


J&D CIVIL ENGINEERS, LLC 401 RAVENELLE ROAD N. GROSVENORDALE, CT 06255 860-923-2920

DESIGNED: DDB


CHECKED: JJB

JOB NO: 18189 DATE: NOVEMBER 4, 2020 SCALE: AS NOTED **SHEET:** 5 **OF** 14

REVISIONS:

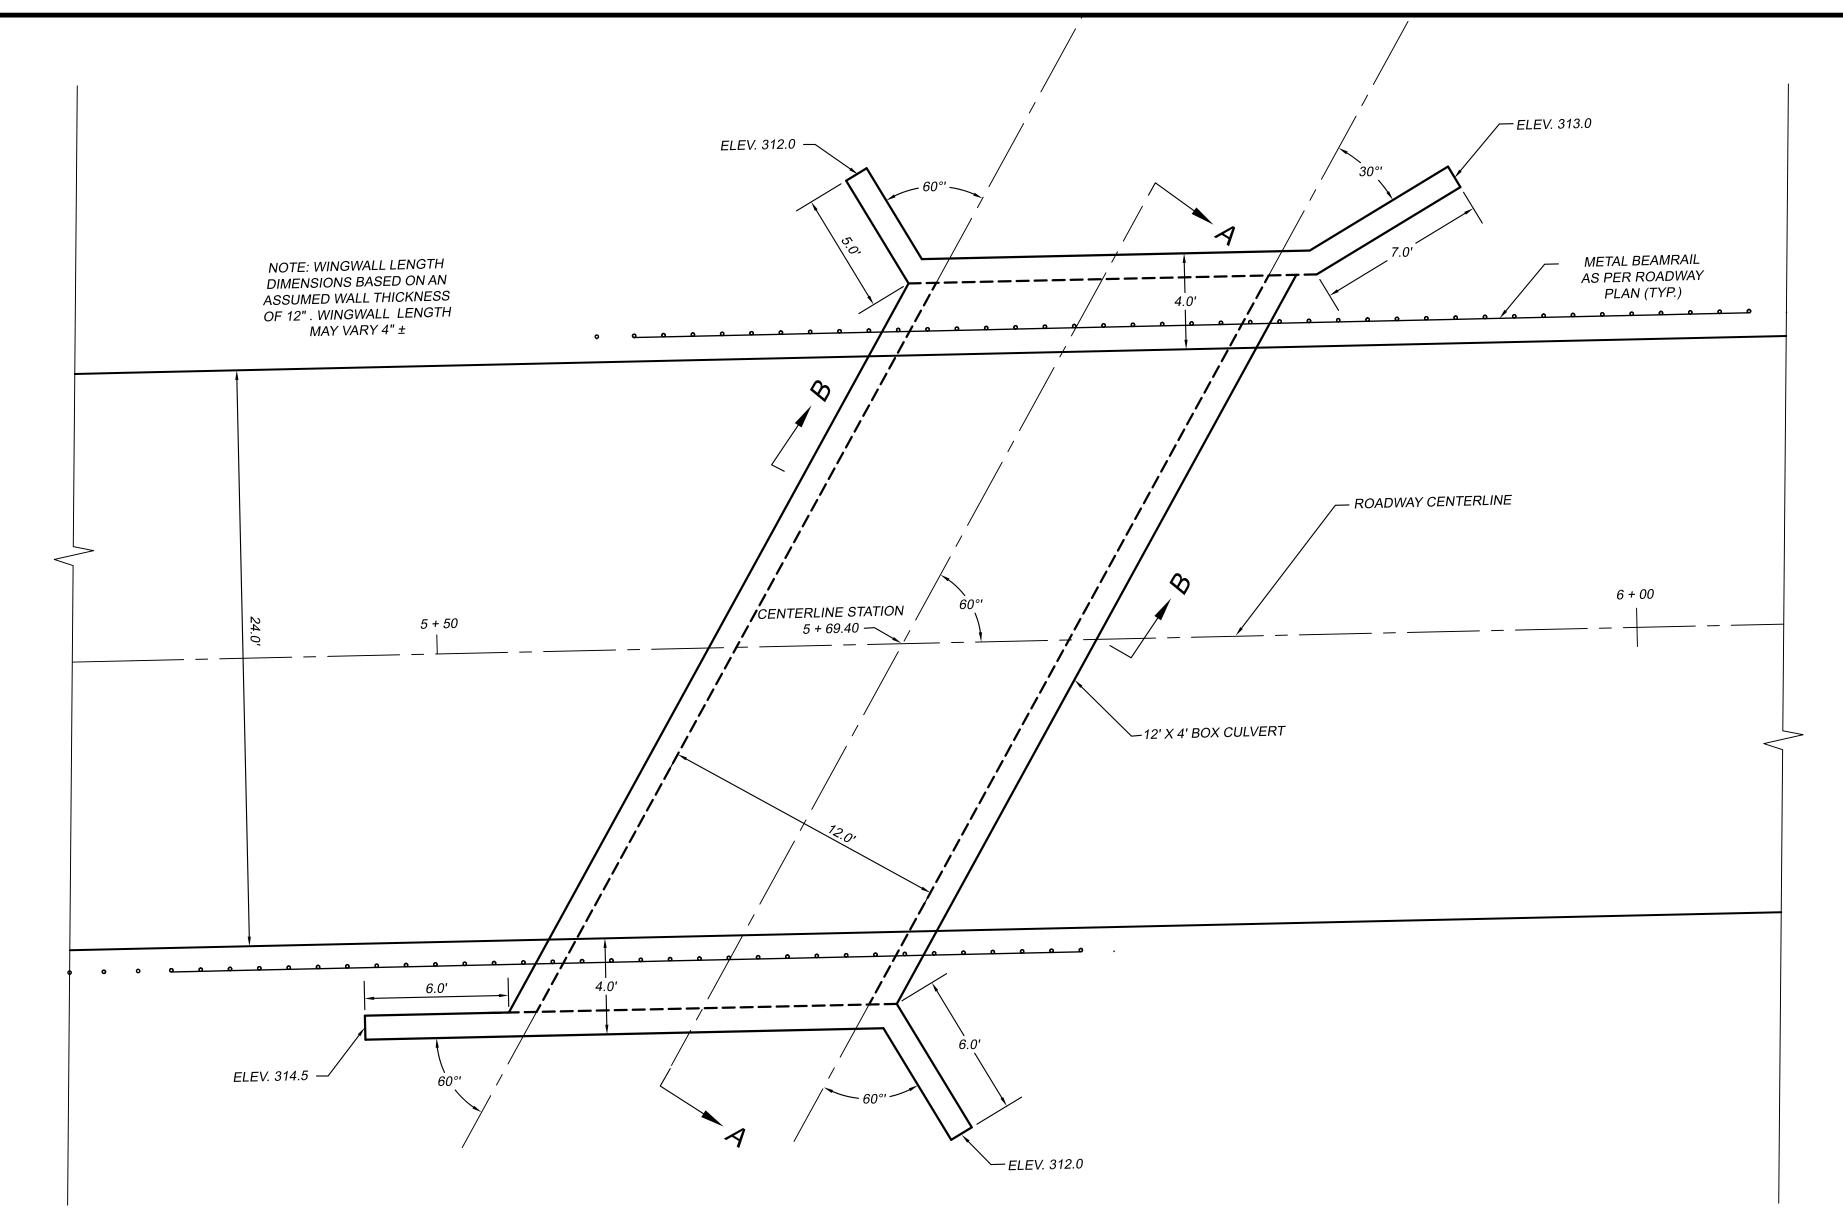

PROPOSED CULVERT PLAN VIEW

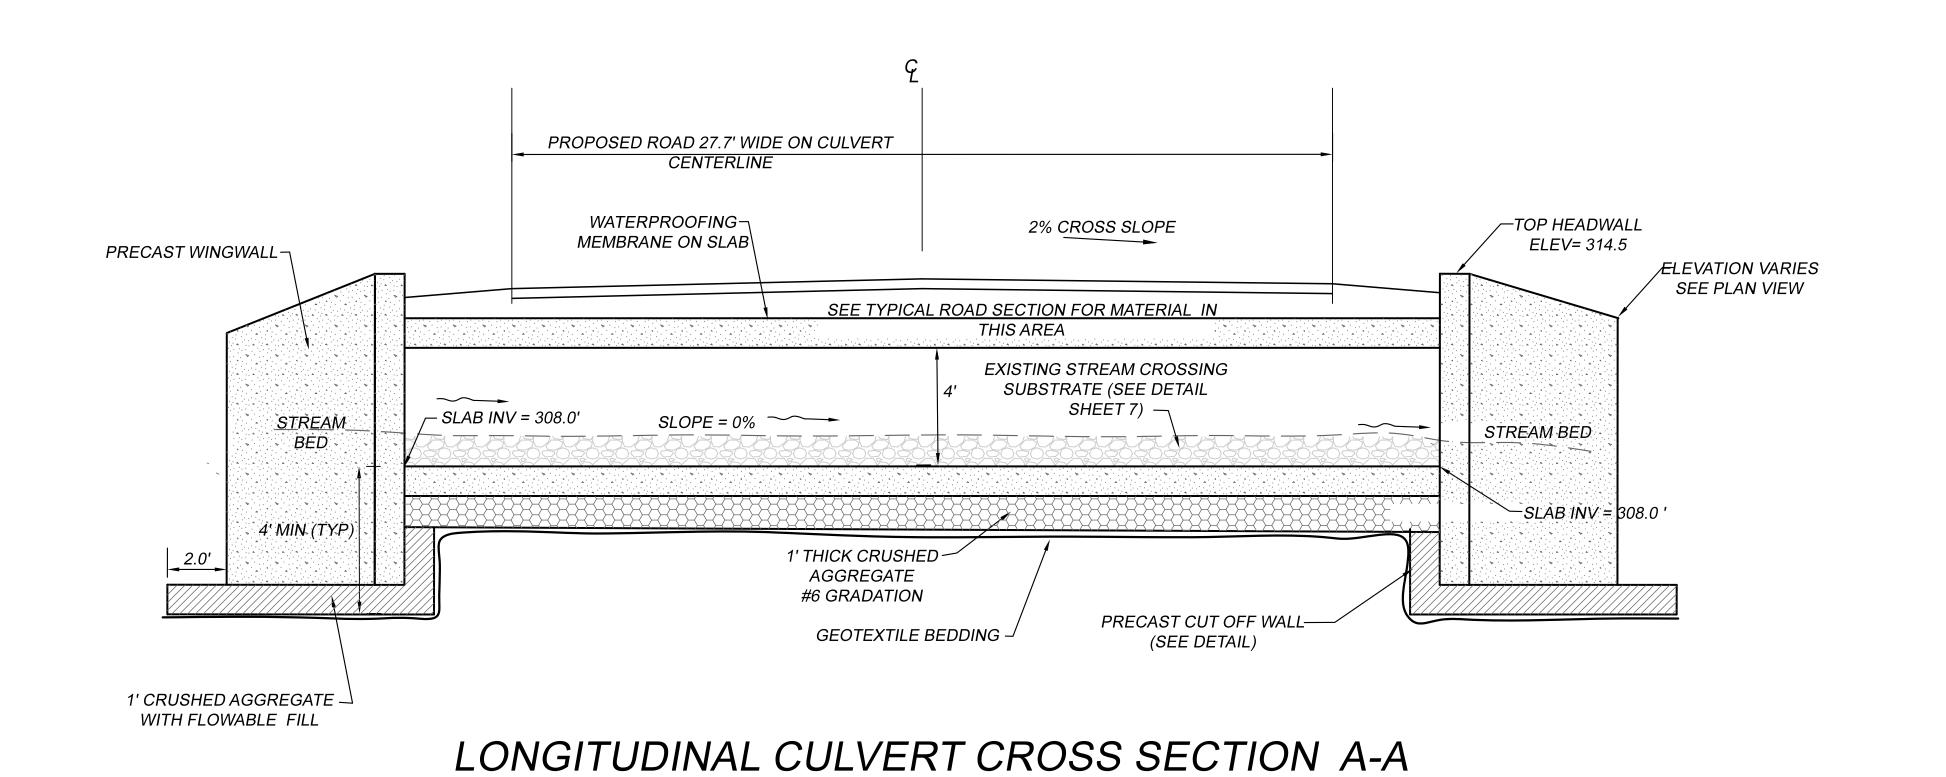

 SOIL & GEOTECHNICAL NOTES

 SIEVE ANALYSIS - NATIVE MATERIAL

 JULY 30, 2019 BY SOIL TECHNOLOGY ASSOCIATES

 US STANDARD SIEVE SIZE 1.5.
 SAMPLE 92.3

 3/4"
 89.5

 3/8"
 78.3

 #4
 65.9

 #8
 53.8

 #16
 42.8


 #30
 32.0

 #50
 17.9


 #100
 8.6


 #200
 2.3

*RETAINED ON NO. 4 SIEVE: 34
SOIL CLASSIFICATION: SW "WITH GRAVEL" (ASTM D-2487)

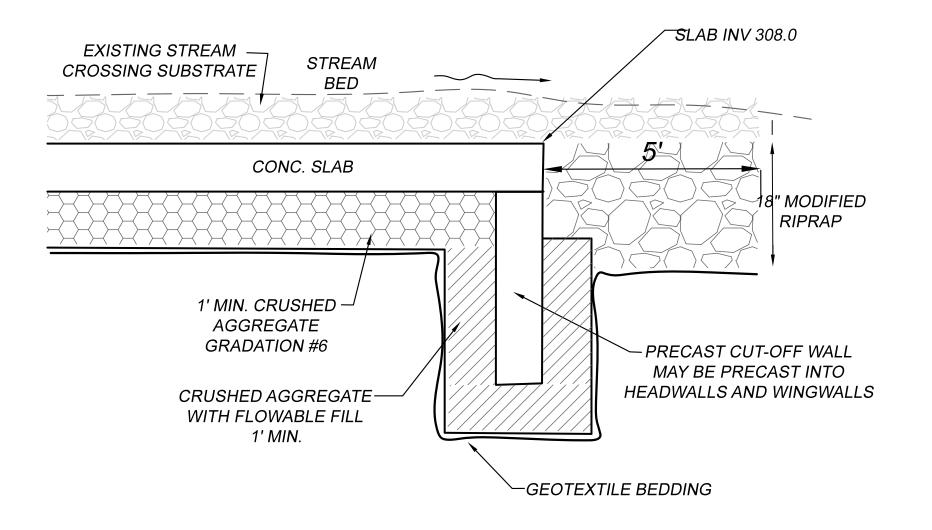


PRECAST CUTOFF WALL
NTS

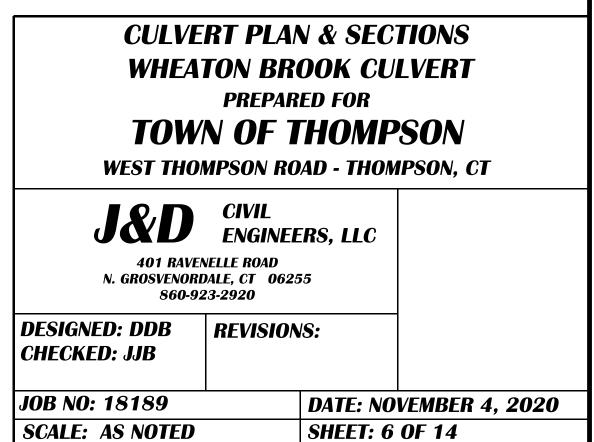

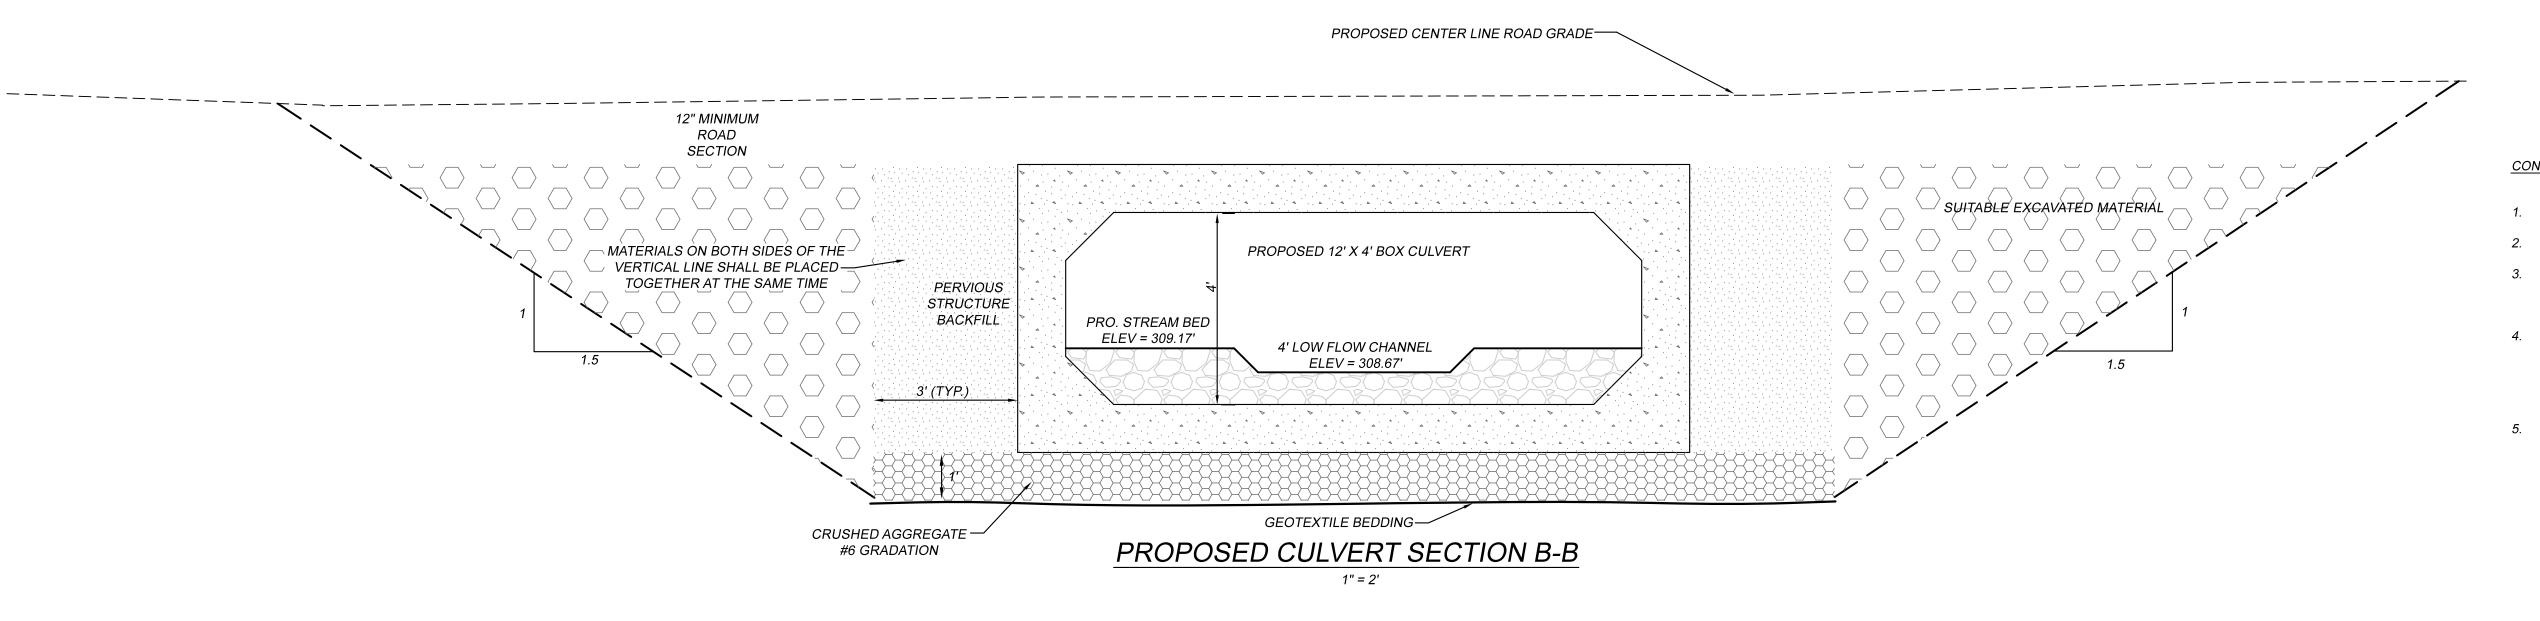

CONSTRUCTION NOTES:

- 1. REINFORCEMENT IN BOX CULVERT AND CUT OFF WALL NOT SHOWN FOR CLARITY.
- 2. IF WEEPHOLES ARE REQUIRED, USE 4" DIA. PIPE AND PREFABRICATED STRUCTURAL DRAIN.
- 3. THE LENGTH OF EACH CULVERT SEGMENT SHALL BE DETERMINED BY THE CONTRACTOR. IF STAGED CONSTRUCTION IS EMPLOYED, THE PRECAST BOX CULVERT SEGMENT LENGTH MUST BE COMPATIBLE WITH STAGING REQUIREMENTS.
- 4. PRECAST CUT-OFF WALLS AND WINGWALLS SHALL BE PLACED ON A LEVELING BED OF CRUSHED MATERIAL MEETING THE REQUIREMENT OF MATERIAL DESIGNATION XXXX, XXX A PRIMARY SIZE DESIGNATION OF X. AFTER PLACING AND LEVELING THE PRECAST UNITS, THE AREAS BENEATH, IN FRONT AND BEHINDTHE UNITS SHALL BE GROUTED WITH CONTROLLED LOW STRENGTH MATERIAL MEETING THE REQUIREMENTS OF SECTION XXX.
- 5. ALL EXPOSED EDGES OF CONCRETE SHALL BE CHAMFERED 1".

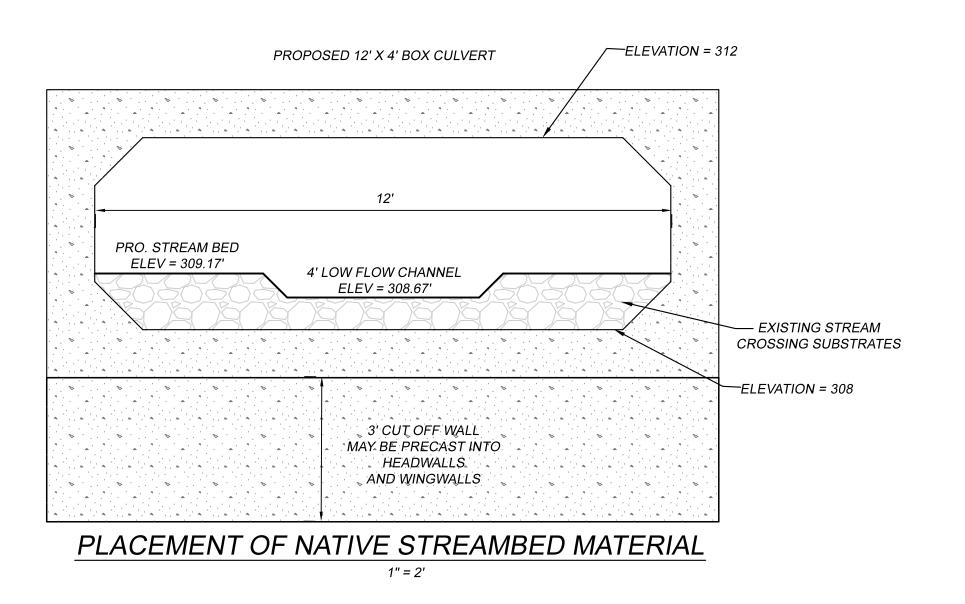

CULVERT DETAILS
WHEATON BROOK CULVERT
PREPARED FOR
TOWN OF THOMPSON
WEST THOMPSON ROAD - THOMPSON, CT

J&D CIVIL ENGINEERS, LLC 401 RAVENELLE ROAD N. GROSVENORDALE, CT 06255


860-923-2920

DESIGNED: DDB REVISIONS:

CHECKED: JJB

DATE: NOVEMBER 4, 2020

JOB NO: 18189 DATE: NOVEMBER
SCALE: AS NOTED SHEET: 7 OF 14

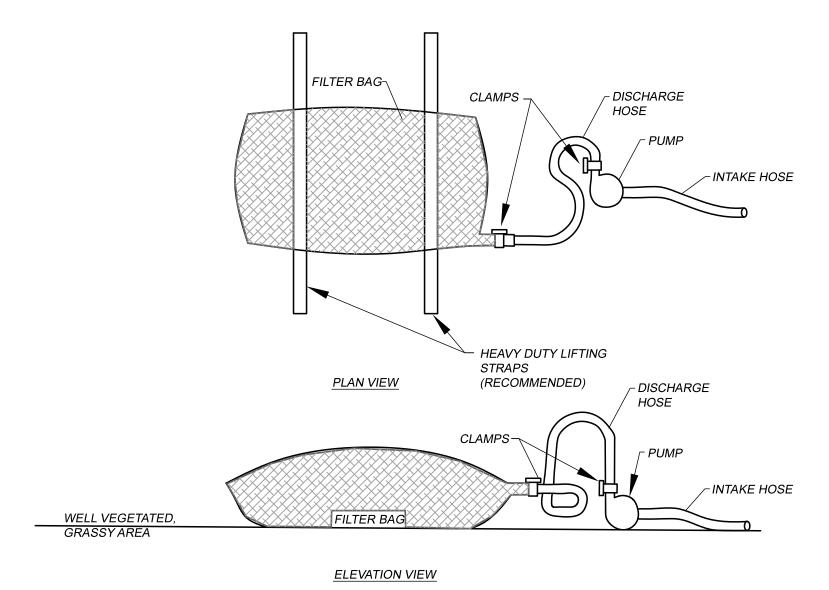

PUMPED WATER FILTER BAG N.T.S.

LOW VOLUME FILTER BAGS SHALL BE MADE FROM NON-WOVEN GEOTEXTILE MATERIAL SEWN WITH HIGH STRENGTH, DOUBLE STITCHED "J" TYPE SEAMS. THEY SHALL BE CAPABLE OF TRAPPING PARTICLES LARGER THAN 150 MICRONS. HIGH VOLUME FILTER BAGS SHALL BE MADE FROM WOVEN GEOTEXTILES THAT MEET THE FOLLOWING STANDARDS:

PROPERTY	TEST METHOD	MIN. STANDARD
AVG. WIDE STRENGTH	ASTM D-4884	60 LB/IN
GRAB TENSILE	ASTM D-4632	205 LB
PUNCTURE	ASTM D-4833	110 LB
MULLEN BURST	ASTM D-3786	350 PSI
UV RESISTANCE	ASTM D-4355	70%
AOS % RETAINED	ASTM D-4751	80 SIEVE

A SUITABLE MEANS OF ACCESSING THE BAG WITH MACHINERY REQUIRED FOR DISPOSAL PURPOSES SHALL BE PROVIDED. FILTER BAGS SHALL BE REPLACED WHEN THEY BECOME 1/2 FULL OF SEDIMENT. SPARE BAGS SHALL BE KEPT AVAILABLE FOR REPLACEMENT OF THOSE THAT HAVE FAILED OR ARE FILLED. BAGS SHALL BE PLACED ON STRAPS TO FACILITATE REMOVAL UNLESS BAGS COME WITH LIFTING STRAPS ALREADY ATTACHED.


BAGS SHALL BE LOCATED IN WELL VEGETATED (GRASSY) AREAS, AND DISCHARGE ONTO STABLE, EROSION RESISTANT AREAS. WHERE IS IS NOT POSSIBLE, A GEOTEXTILE UNDERLAYMENT AND FLOW PATH SHALL BE PROVIDED. BAGS MAY BE PLACE ON FILTER STONE TO INCREASE DISCHARGE CAPACITY. BAGS SHALL NOT BE PLACED ON SLOPES GREATER THAN 5%. FOR SLOPES EXCEEDING 5%, CLEAN ROCK OR OTHER NON-ERODIBLE AND NON-POLLUTING MATERIAL MAY BE PLACED UNDER THE BAD TO REDUCE SLOPE STEEPNESS.

NO DOWNSLOPE SEDIMENT BARRIER IS REQUIRED FOR MOST INSTALLATIONS. COMPOST BERM OR COMPOST FILTER SOCK SHALL BE INSTALLED BELOW BAGS, WITHIN 50' OF ANY RECEIVING SURFACE WATER OR WHERE GRASSY AREA IS NOT AVAILABLE.


THE PUMP DISCHARGE HOSE SHALL BE INSERTED INTO THE BAGS IN THE MANNER SPECIFIED BY THE MANUFACTURER AND SECURELY CLAMPED. A PIECE OF PVC PIPE IS RECOMMENDED FOR THIS PURPOSE.

THE PUMPING RATE SHALL BE NO GREATER THAN 750 GPM OR 1/2 THE MAXIMUM SPECIFIED BY THE MANUFACTURER, WHICHEVER IS LESS. PUMP INTAKES SHALL BE FLOATING AND SCREENED.


FILTER BAGS SHALL BE INSPECTED DAILY. IF ANY PROBLEM IS DETECTED, PUMPING SHALL CEASE IMMEDIATELY AND NOT RESUME UNTIL THE PROBLEM IS CORRECTED.

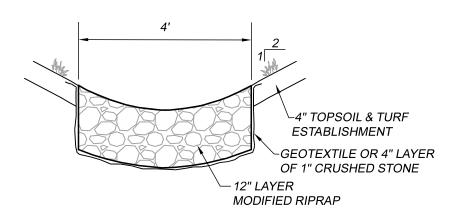


RIPRAP LEAKOFF SWALE

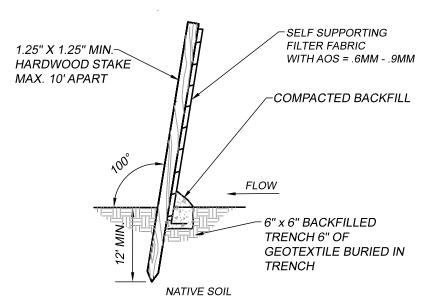

SILT FENCE INSTALLATION NOT TO SCALE

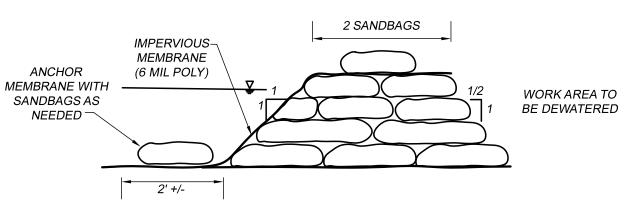

TYPICAL SMALL BAG INSTALLATION

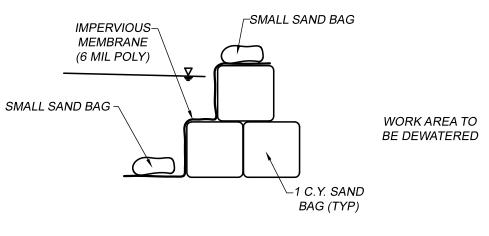


TYPICAL LARGE BAG (1 C.Y.) INSTALLATION

INSTALLATION NOTES:

- 1. THE UPSTREAM COFFERDAM IS INSTALLED FIRST. REMOVE LARGE ROCKS ON STREAMBED THAT WOULD INTERFERE WITH SEAL. THICK MIL POLY SHEETING IS LAID ALONG THE STREAMBED BEFORE THE SANDBAGS ARE PLACED.
- 2. THE EXCESS PLASTIC IS THEN FOLDED OVER THE SANDBAGS IN THE UPSTREAM DIRECTION AND ANOTHER LAYER OF SANDBAGS IS PLACED ON THE PLASTIC TO HELP SEAL THE DAM FROM INFILTRATION. THE PLASTIC IS THEN EXTENDED ALONG THE STREAM BOTTOM AS FAR UPSTREAM AS PRACTICABLE TO INCREASE THE FLOW LENGTH OF THE SUBSURFACE FLOW. THIS HELPS PREVENT FLOW FROM GOING BENEATH THE SANDBAG COFFERDAM.
- WHEN INDUSTRIAL SANDBAGS ARE USED, ADDITIONAL SMALL SANDBAGS MAY BE PLACED IN BETWEEN THE LARGE SANDBAGS TO HELP SEAL THE WORK AREA. ONCE THE UPSTREAM COFFERDAM IS SECURED, THE CONTRACTOR WILL BEGIN
- DIVERTING UPSTREAM FLOWS AROUND THE COFFERDAM AREA USING A BYPASS PUMP. THIS WATER WILL BE DISCHARGED DIRECTLY INTO THE FILTER BAG. 5. THE DOWNSTREAM COFFERDAM WILL THEN BE INSTALLED IN THE SAME MANNER AS THE UPSTREAM COFFERDAM. THE DOWNSTREAM COFFERDAM ACTS AS A
- CONTROL DOWNSTREAM BACKWATER SITUATIONS. 6. CONTRACTOR MAY USE JERSEY BARRIERS OR PRECAST CONCRETE BLOCKS IN LIEU OF SANDBAGS.

SAFEGUARD AGAINST A FAILURE OF THE UPSTREAM COFFERDAM AND TO

COFFER DAM DETAIL NOT TO SCALE

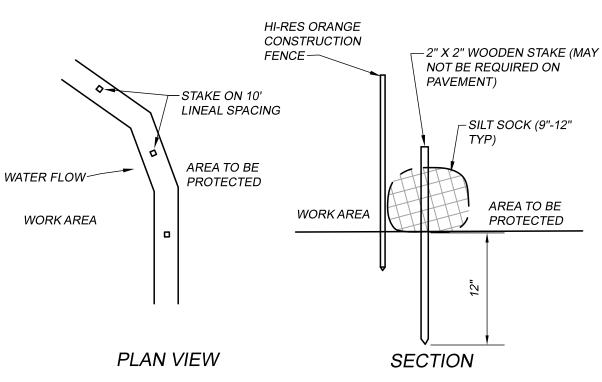

- 1. SILT SOCK MANUFACTURER SHALL BE SILT SOXX OR
- ENGINEER APPROVED EQUAL
- 2. ALL MATERIAL TO MEET MANUFACTURER'S SPECIFICATIONS 3. SEDIMENT SILT SOCK TO BE FILLED WITH LEAF COMPOST AND/OR
- WOODY MULCH PER MANUFACTURER'S REQUIREMENTS. 4. FOLLOWING CONSTRUCTION AND SITE STABILIZATION, COMPOST
- MATERIAL SHALL BE REMOVED OR DISPERSED ON SITE, AS APPROVED BY THE ENGINEER.

SILT SOCK DETAIL NOT TO SCALE

GENERAL CONSTRUCTION NOTES:

LOCATIONS OF UNDERGROUND UTILITIES HAVE BEEN DETERMINED FROM THE BEST INFORMATION AVAILABLE AND ARE GIVEN FOR THE CONVENIENCE OF THE CONTRACTOR. THE ENGINEER ASSUMES NO RESPONSIBILITY FOR THEIR ACCURACY. THE CONTRACTOR SHALL NOTIFY CALL BEFORE YOU DIG AND FIELD VERIFY THE LOCATION, DEPTH AND ALIGNMENT OF ALL EXISTING PIPES, CABLES, ETC.

CONSTRUCTION SHALL BE IN CONFORMANCE WITH CONNDOT FORM 818 UNLESS OTHERWISE NOTED ON THE PLANS. UTILITY INSTALLATION SHALL BE IN CONFORMANCE WITH THE APPROPRIATE UTILITY COMPANY.

THE CONTRACTOR IS RESPONSIBLE FOR ALL COORDINATION WITH EACH UTILITY AND ALL COSTS ASSOCIATED WITH THE PROTECTION OF EXISTING FACILITIES. IT IS THE CONTRACTOR'S RESPONSIBILITY TO MAINTAIN IN SERVICE ALL EXISTING PIPING UNLESS OTHERWISE INDICATED ON THE DRAWINGS.

TYPICAL DETAILS SHOWN ARE TO ILLUSTRATE THE ENGINEER'S INTENT AND ARE NOT PRESENTED AS A SOLUTION TO ALL CONSTRUCTION PROBLEMS ENCOUNTERED IN THE FIELD. THE CONTRACTOR MAY SUBMIT PROPOSALS FOR ALTERNATE METHODS TO SUIT FIELD CONDITIONS.

ALL TRENCHING SHALL BE DONE IN COMPLIANCE WITH OSHA REGULATIONS AND THE INSTALLATION REQUIREMENTS OF THE PIPE MANUFACTURER.THE OSHA CLASSIFICATION FOR SOILS AT THIS SITE IS "C" WHICH REQUIRES ALL EXCAVATIONS IN EXCESS OF 5' TO BE SHORED OR CUT BACK TO A SLOPE OF 1.5 HORIZONTAL TO 1.0 VERTICAL. IF SHORING IS REQUIRED, IT MUST BE DESIGNED BY A LICENSED CT PROFESSIONAL

BENCHMARKS WILL BE PROVIDED FOR THE CONVENIENCE OF THE CONTRACTOR IN LAYING OUT THE PROJECT. ANY DISCREPANCIES BETWEEN FIELD MEASUREMENTS AND THE PLANS SHALL BE BROUGHT TO THE ATTENTION OF THE ENGINEER IMMEDIATELY.

THE CONTRACTOR SHALL PROTECT BENCHMARKS, PROPERTY CORNERS AND SURVEY MONUMENTS FROM DAMAGE OR DISPLACEMENT. ANY SUCH ITEMS WHICH NEED TO BE REPLACED SHALL BE AT THE CONTRACTOR'S EXPENSE.

SOIL EROSION CONTROL PLAN

THE PURPOSE OF THIS PROJECT IS TO REPLACE THE WHEATON BROOK CULVERT ON WEST THOMPSON ROAD AND RECONSTURCT APPROXIMATELY 300' OF ROAD. THE GOAL OF THE EROSION CONTROL PLAN IS TO PROHIBIT ANY ERODED SEDIMENT OR SEDIMENT LADEN RUNOFF FROM ENTERING WHEATON BROOK OR ADJACENT WETLANDS. THE SITE CONTRACTOR SHALL INSTALL ADDITIONAL EROSION CONTROL DEVICES AS NEEDED, BEYOND WHAT IS INDICATED ON THE PLAN, SUCH AS HAYBALES, SILT SOCK, STONE CHECK DAMS ETC, TO ENSURE THAT NO SEDIMENT ERODES FROM THE SITE.

CONSTRUCTION SEQUENCE

- 1. A PRE-CONSTRUCTION MEETING SHALL BE HELD WITH THE CONTRACTOR, HIGHWAY DEPARTMENT, ENGINEER AND WETLANDS AGENT.
- INSTALLATION OF SEDIMENT CONTROL BARRIERS AS SHOWN ON THE PLAN.
- REMOVE EXISTING GUIDE RAIL.
- 4. REVIEW THE INSTALLATION NOTES FOR THE PUMPED WATER FILTER BAG AND THE SAND BAG COFFER DAM DETAILS.
- 5. INSTALL THE FILTER BAG WHERE SHOWN ON THE PLANS.
- 6. INSTALL THE UPSTREAM COFFERDAM AROUND THE INLET LOCATION OF THE
- TEMPORARY BYPASS CULVERT FIRST AS PER THE DETAIL. 7. ONCE THE UPSTREAM COFFERDAM IS SECURED, BEGIN PUMPING THE EXCAVATION AREA FOR THE TEMPORARY BYPASS CULVERT. PUMP INTO TO THE FILTER BAG IF
- SEDIMENT IF FLOWING DOWNSTREAM. 8. EXCAVATE WITHIN THE ROAD FOR THE TEMPORARY BYPASS CULVERT AND INSTALL
- FROM UPSTREAM TO DOWNSTREAM. 9. THE TEMPORARY BYPASS CULVERT WILL ALLOW FOR CONTINUOUS RIVER FLOW
- DURING CONSTRUCTION. 10. AFTER THE TEMPORARY BYPASS CULVERT IS INSTALLED THE UPSTREAM COFFERDAM SHALL BE SLOWLY AND CAREFULLY REMOVED FROM THE TEMPORARY
- CULVERT AND REINSTALLED FOR THE PERMANENT CULVERT. 11. INSTALL DOWNSTREAM COFFERDAM FOR THE PERMANENT CULVERT AND BEGIN
- PUMPING TO FILTER BAG. 12. MONITOR THE FLOW TO MAKE SURE THAT IT IS FREE FROM SEDIMENT PRIOR TO IT ENTERING THE BROOK DOWNSTREAM. IF SEDIMENT IS OBSERVED, STOP THE PUMPING OPERATIONS AND INSTALL AN ADDITIONAL PUMPING SETTLING BASIN
- COMPRISED OF HAYBALES AND NON-WOVEN GEOTEXTILE AS PER CHAPTER 5-13 OF
- THE 2002 CT GUIDELINES FOR SOIL EROSION AND SEDIMENT CONTROL. 13. CONTINUE PUMPING AS NEEDED DURING THE CONSTRUCTION OF THE
- REPLACEMENT CULVERT UNTIL REMOVAL OF COFFERDAM IS HAS BEGUN. 14. REMOVE EXISTING BRIDGE.
- 15. INSTALL NEW PRECAST CONCRETE CULVERT.
- 16. REMOVE COFFERDAMS.
- 17. BLOCK INLET OF TEMPORARY BYPASS CULVERT AND REMOVE FROM DOWNSTREAM TO
- UPSTREAM. PLACE AND COMPACT SUBGRADE MATERIAL. 18. PLACE AND COMPACT SUBGRADE MATERAL
- 19. PLACE AND COMPACT SUBBASE AND BASE

THIS EROSION AND SEDIMENT CONTROL PLAN.

- 20. PAVE ROAD
- 21. HYDROSEED AND HAY COVER OVER DISTURBED AREAS
- 22. INSTALL GUIDE RAIL
- 23. COMPLETE SITE STABILIZATION AND REMOVE EROSION CONTROL

OPERATIONS AND MAINTENANCE

- 1. ALL PROPOSED WORK SHALL CONFORM TO "2002 CONNECTICUT GUIDELINES FOR SOIL EROSION AND SEDIMENT CONTROL" BY THE CONNECTICUT COUNCIL OF SOIL AND WATER CONSERVATION AND TOWN REGULATIONS.
- 2. THE CONTRACTOR IS RESPONSIBLE FOR ENSURING THAT THE GOALS OF THIS EROSION CONTROL PLAN ARE MET BY WHATEVER MEANS ARE NECESSARY. THE CONTRACTOR SHALL PLAN ALL LAND DISTURBING ACTIVITIES IN A MANNER AS TO MINIMIZE THE EXTENT OF DISTURBED AREAS.
- 3. DAILY INSPECTIONS SHALL BE MADE OF EROSION AND SEDIMENT CONTROL MEASURES TO INSURE EFFECTIVENESS AND IMMEDIATE CORRECTIVE ACTION SHALL BE TAKEN IF FAILURE OCCURS. ADDITIONAL EROSION CONTROL MEASURES BEYOND WHAT IS SHOWN ON THE PLAN MAY BE NECESSARY.
- 4. EROSION AND SEDIMENT CONTROL MEASURES SHALL REMAIN IN PLACE UNTIL DISTURBED AREAS HAVE BEEN STABILIZED AND VEGETATIVE COVER HAS BEEN ESTABLISHED 5. THE CONTRACTOR SHALL BE RESPONSIBLE FOR IMPLEMENTATION AND MAINTENANCE OF

EROSION AND SEDIMENT CONTROL CONSTRUCTION DETAILS WHEATON BROOK CULVERT PREPARED FOR TOWN OF THOMPSON

WEST THOMPSON ROAD - THOMPSON, CT

ENGINEERS, LLC 401 RAVENELLE ROAD N. GROSVENORDALE, CT 06255

860-923-2920


DESIGNED: DDB CHECKED: JJB

JOB NO: 18189

DATE: NOVEMBER 4, 2020

| SCALE: AS NOTED **SHEET:** 8 **OF** 14

REVISIONS:

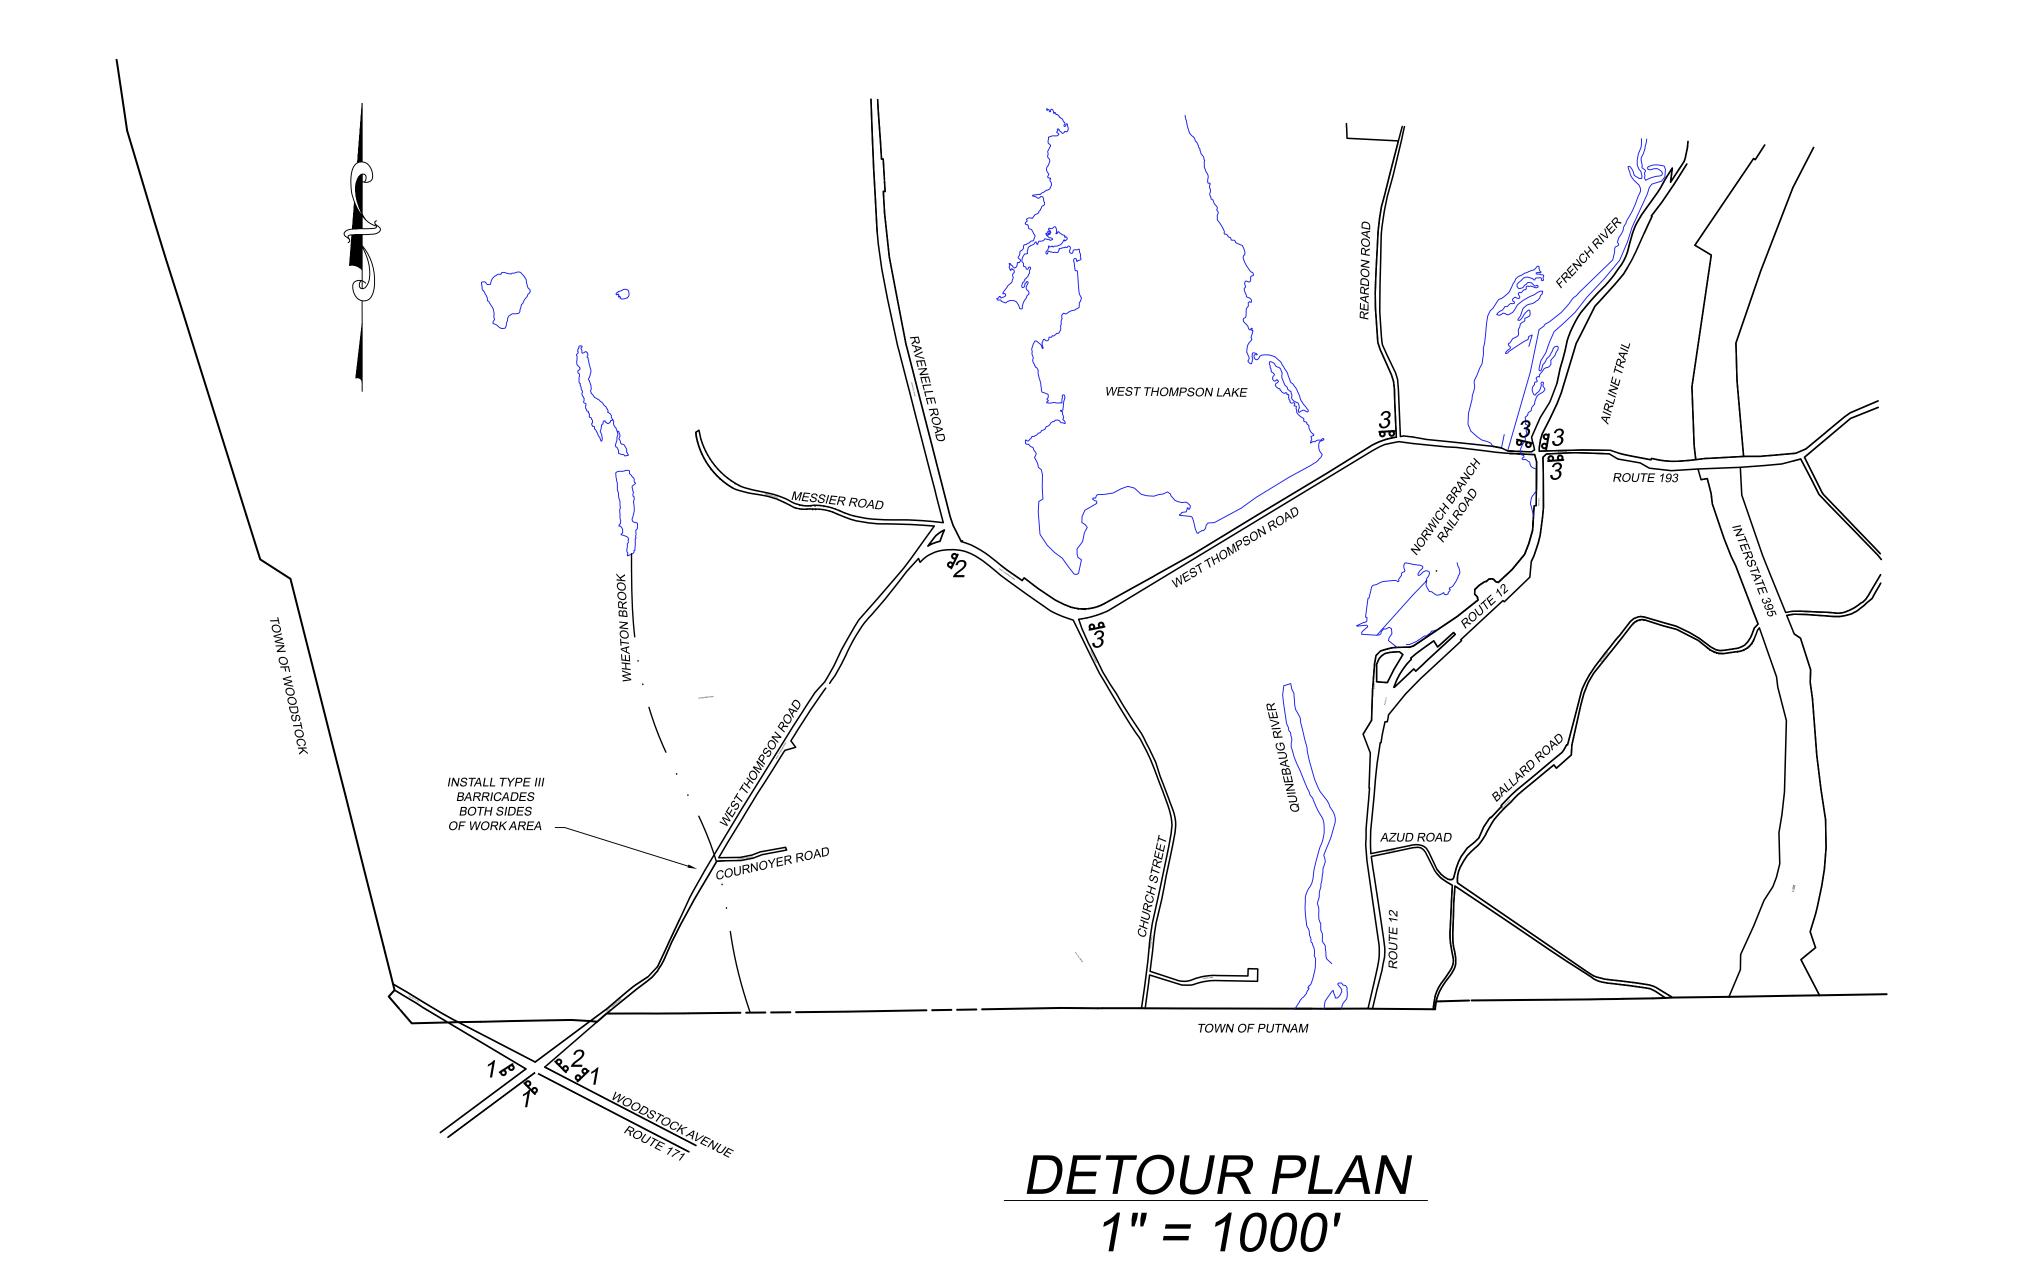

(PROVIDE 3 SIGNS)

WEST THOMPSON ROAD CLOSED 2500' AHEAD LOCAL TRAFFIC ONLY

80-9928

(PROVIDE 5 SIGNS)

WEST THOMPSON ROAD CLOSED PAST RAVENELLE RD LOCAL TRAFFIC ONLY

80-9928

ROAD CLOSED THRU TRAFFIC

(PROVIDE 2 SIGNS)

80-9081

└─ SILVER BACKGROUND WITH TYPE 1 SHEETING

DETOUR NOTES:

- 1. INSTALL SIGNS AS PER CT DOT AND THE MANUAL OF UNIFORM TRAFFIC DEVICES.
- 2. INSTALL SIGNS WITHIN ROAD R.O.W. AND NOT ON PRIVATE PROPERTY.
- 3. SIGNS SHALL BE INSTALLED NO SOONER THAN TWO DAYS PRIOR TO ACTUAL ROAD CLOSING AND INSTALLATION OF BARRIERS.
- 4. THE SIGNS SHALL BE REMOVED IMMEDIATELY FOLLOWING REMOVAL OF BARRIERS. SIGNS SHALL BECOME THE PROPERTY OF THE TOWN OF THOMPSON AND SHALL BE DELIVERED TO THE HIGHWAY DEPARTMENT ON BUCKLEY HILL ROAD.
- 5. SEE SPECIFICATIONS. ROAD CLOSING SHALL BE LIMITED TO 14 DAYS.

ROAD CLOSURE & SIGNAGE WHEATON BROOK CULVERT PREPARED FOR TOWN OF THOMPSON WEST THOMPSON ROAD - THOMPSON, CT


401 RAVENELLE ROAD N. GROSVENORDALE, CT 06255 860-923-2920

DESIGNED: JJB CHECKED: DDB

REVISIONS:


DATE: NOVEMBER 4, 2020

JOB NO: 18189 **SCALE:** 1" = 1000' **SHEET: 9 OF 14**

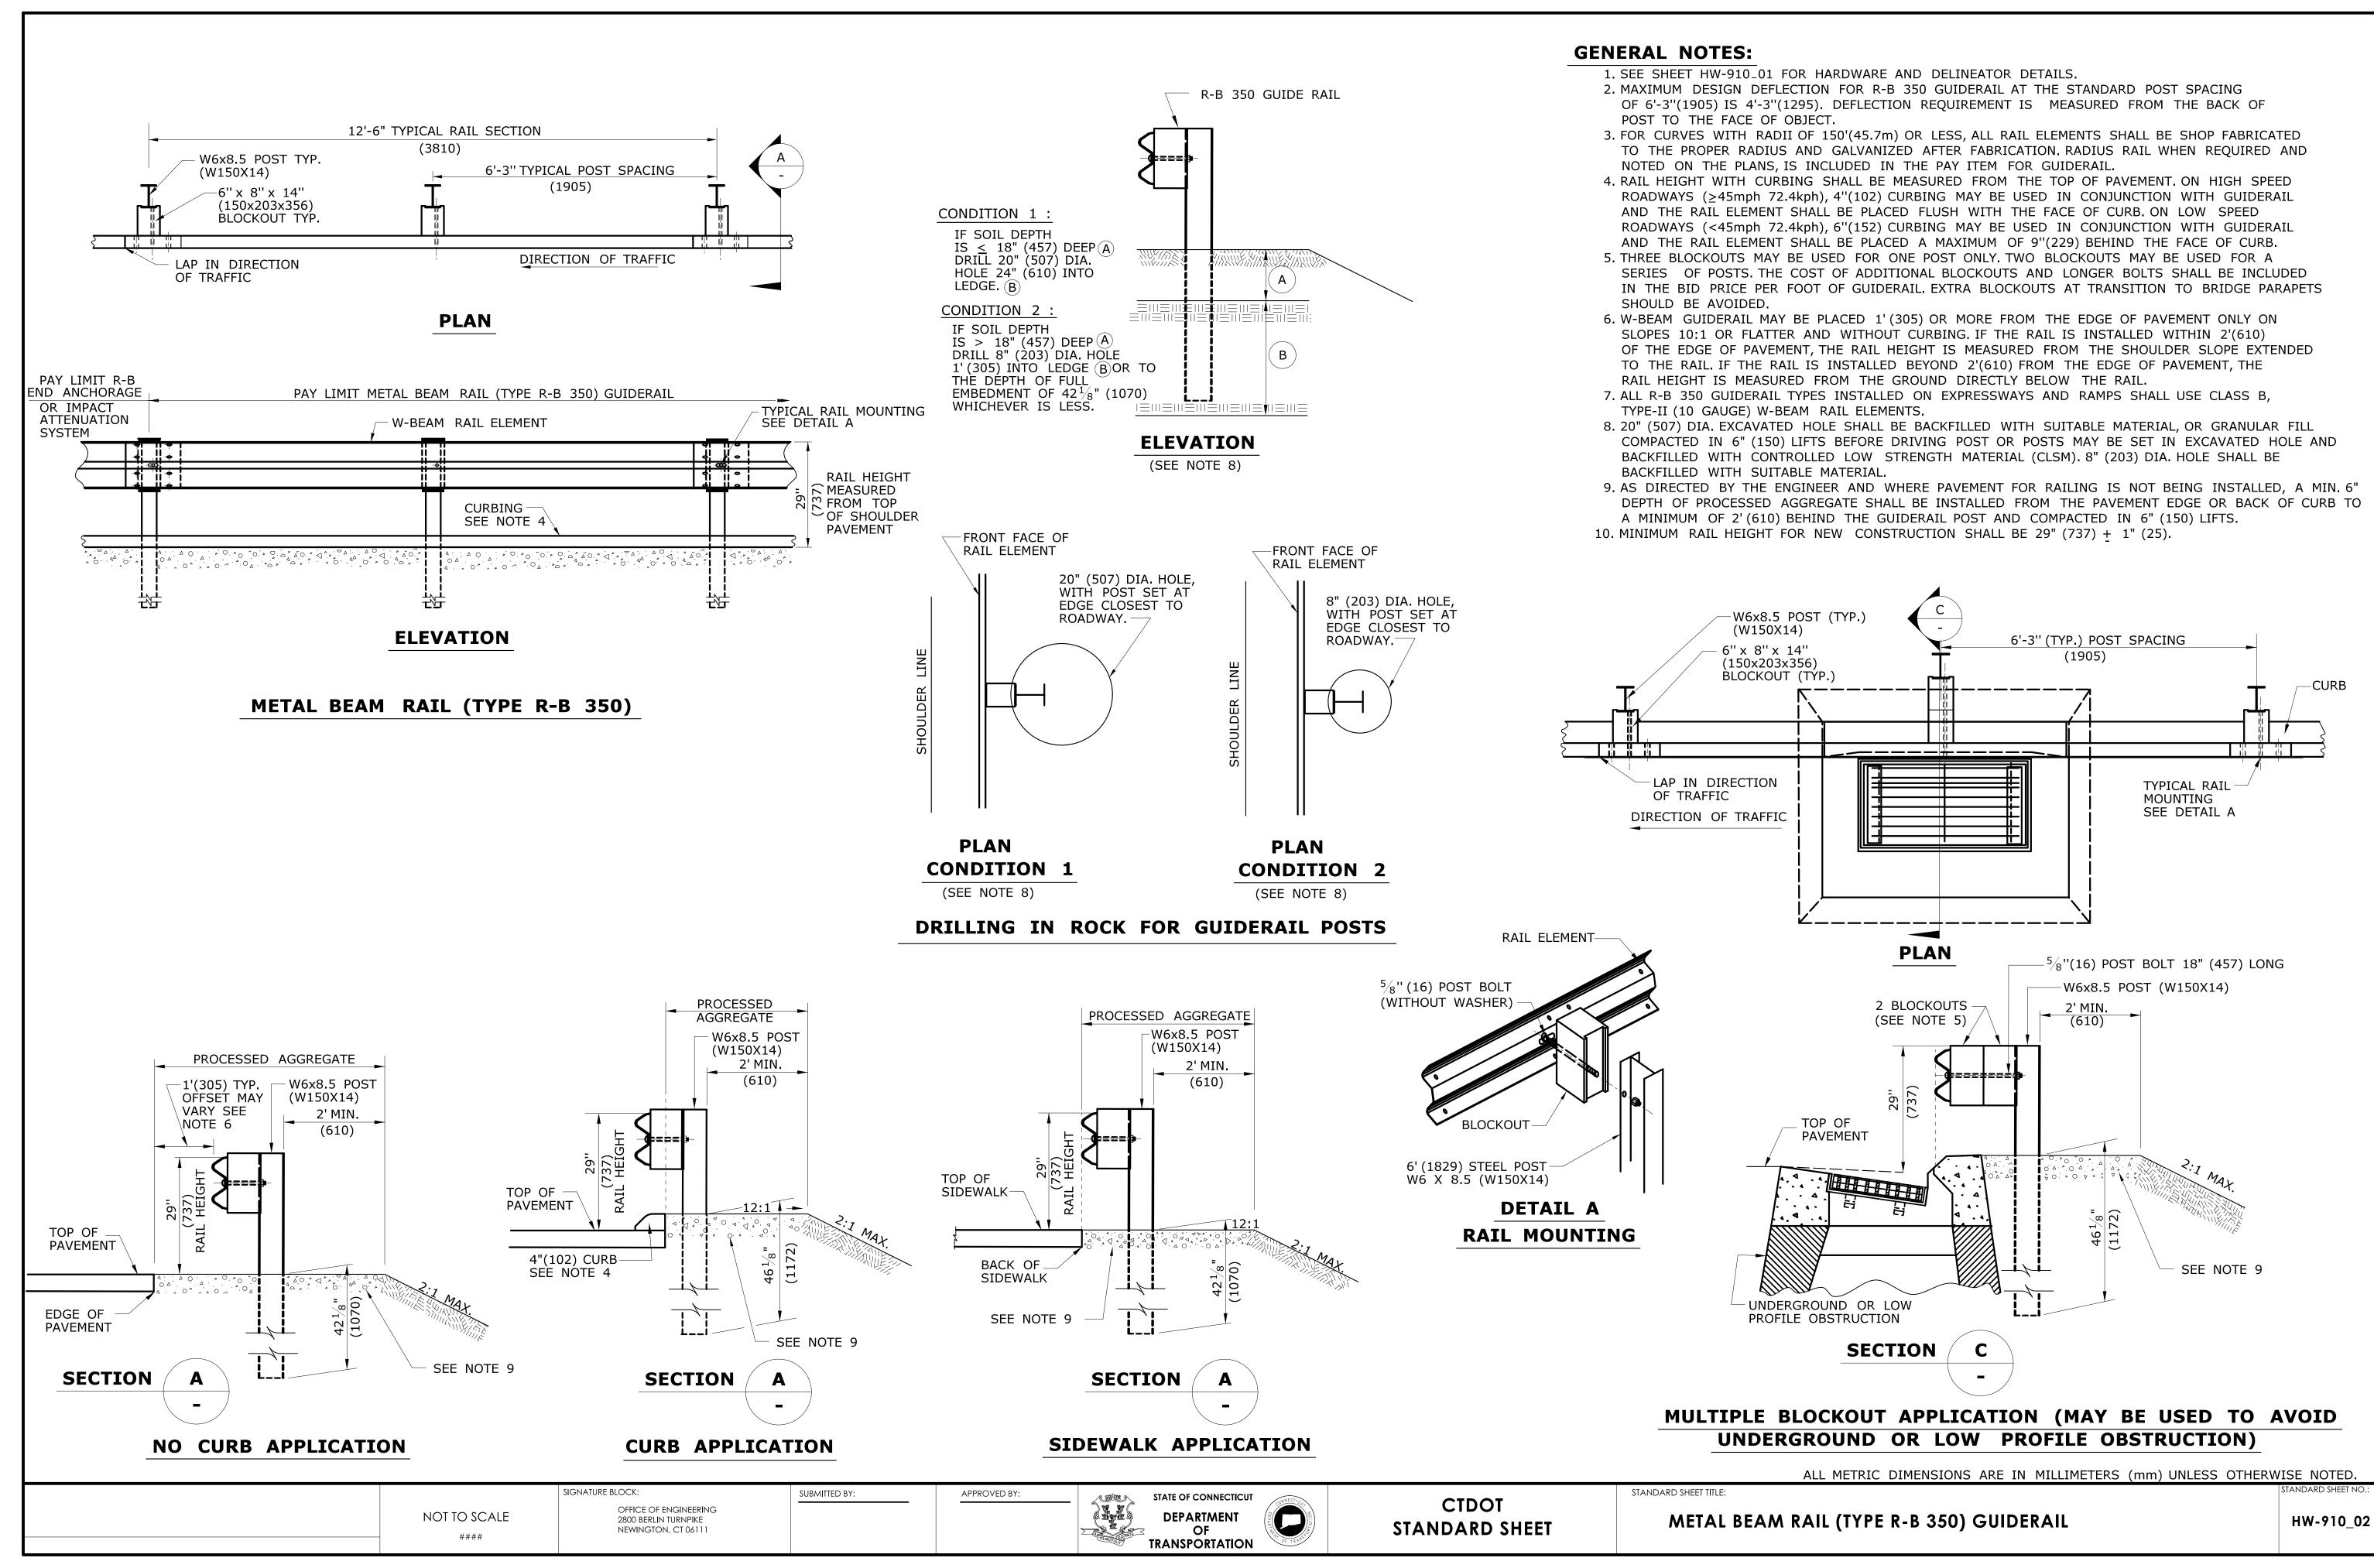

Agenda Item E.b) 3. New Applications

WAA20045, James Fogarty, 0 Brickyard Rd. (Assessor's map 38. block 87, lot 6), construction of a driveway in the 100-foot upland review area for a new single family home, stamped receive by the Town Clerk 11/3/2020, under review.

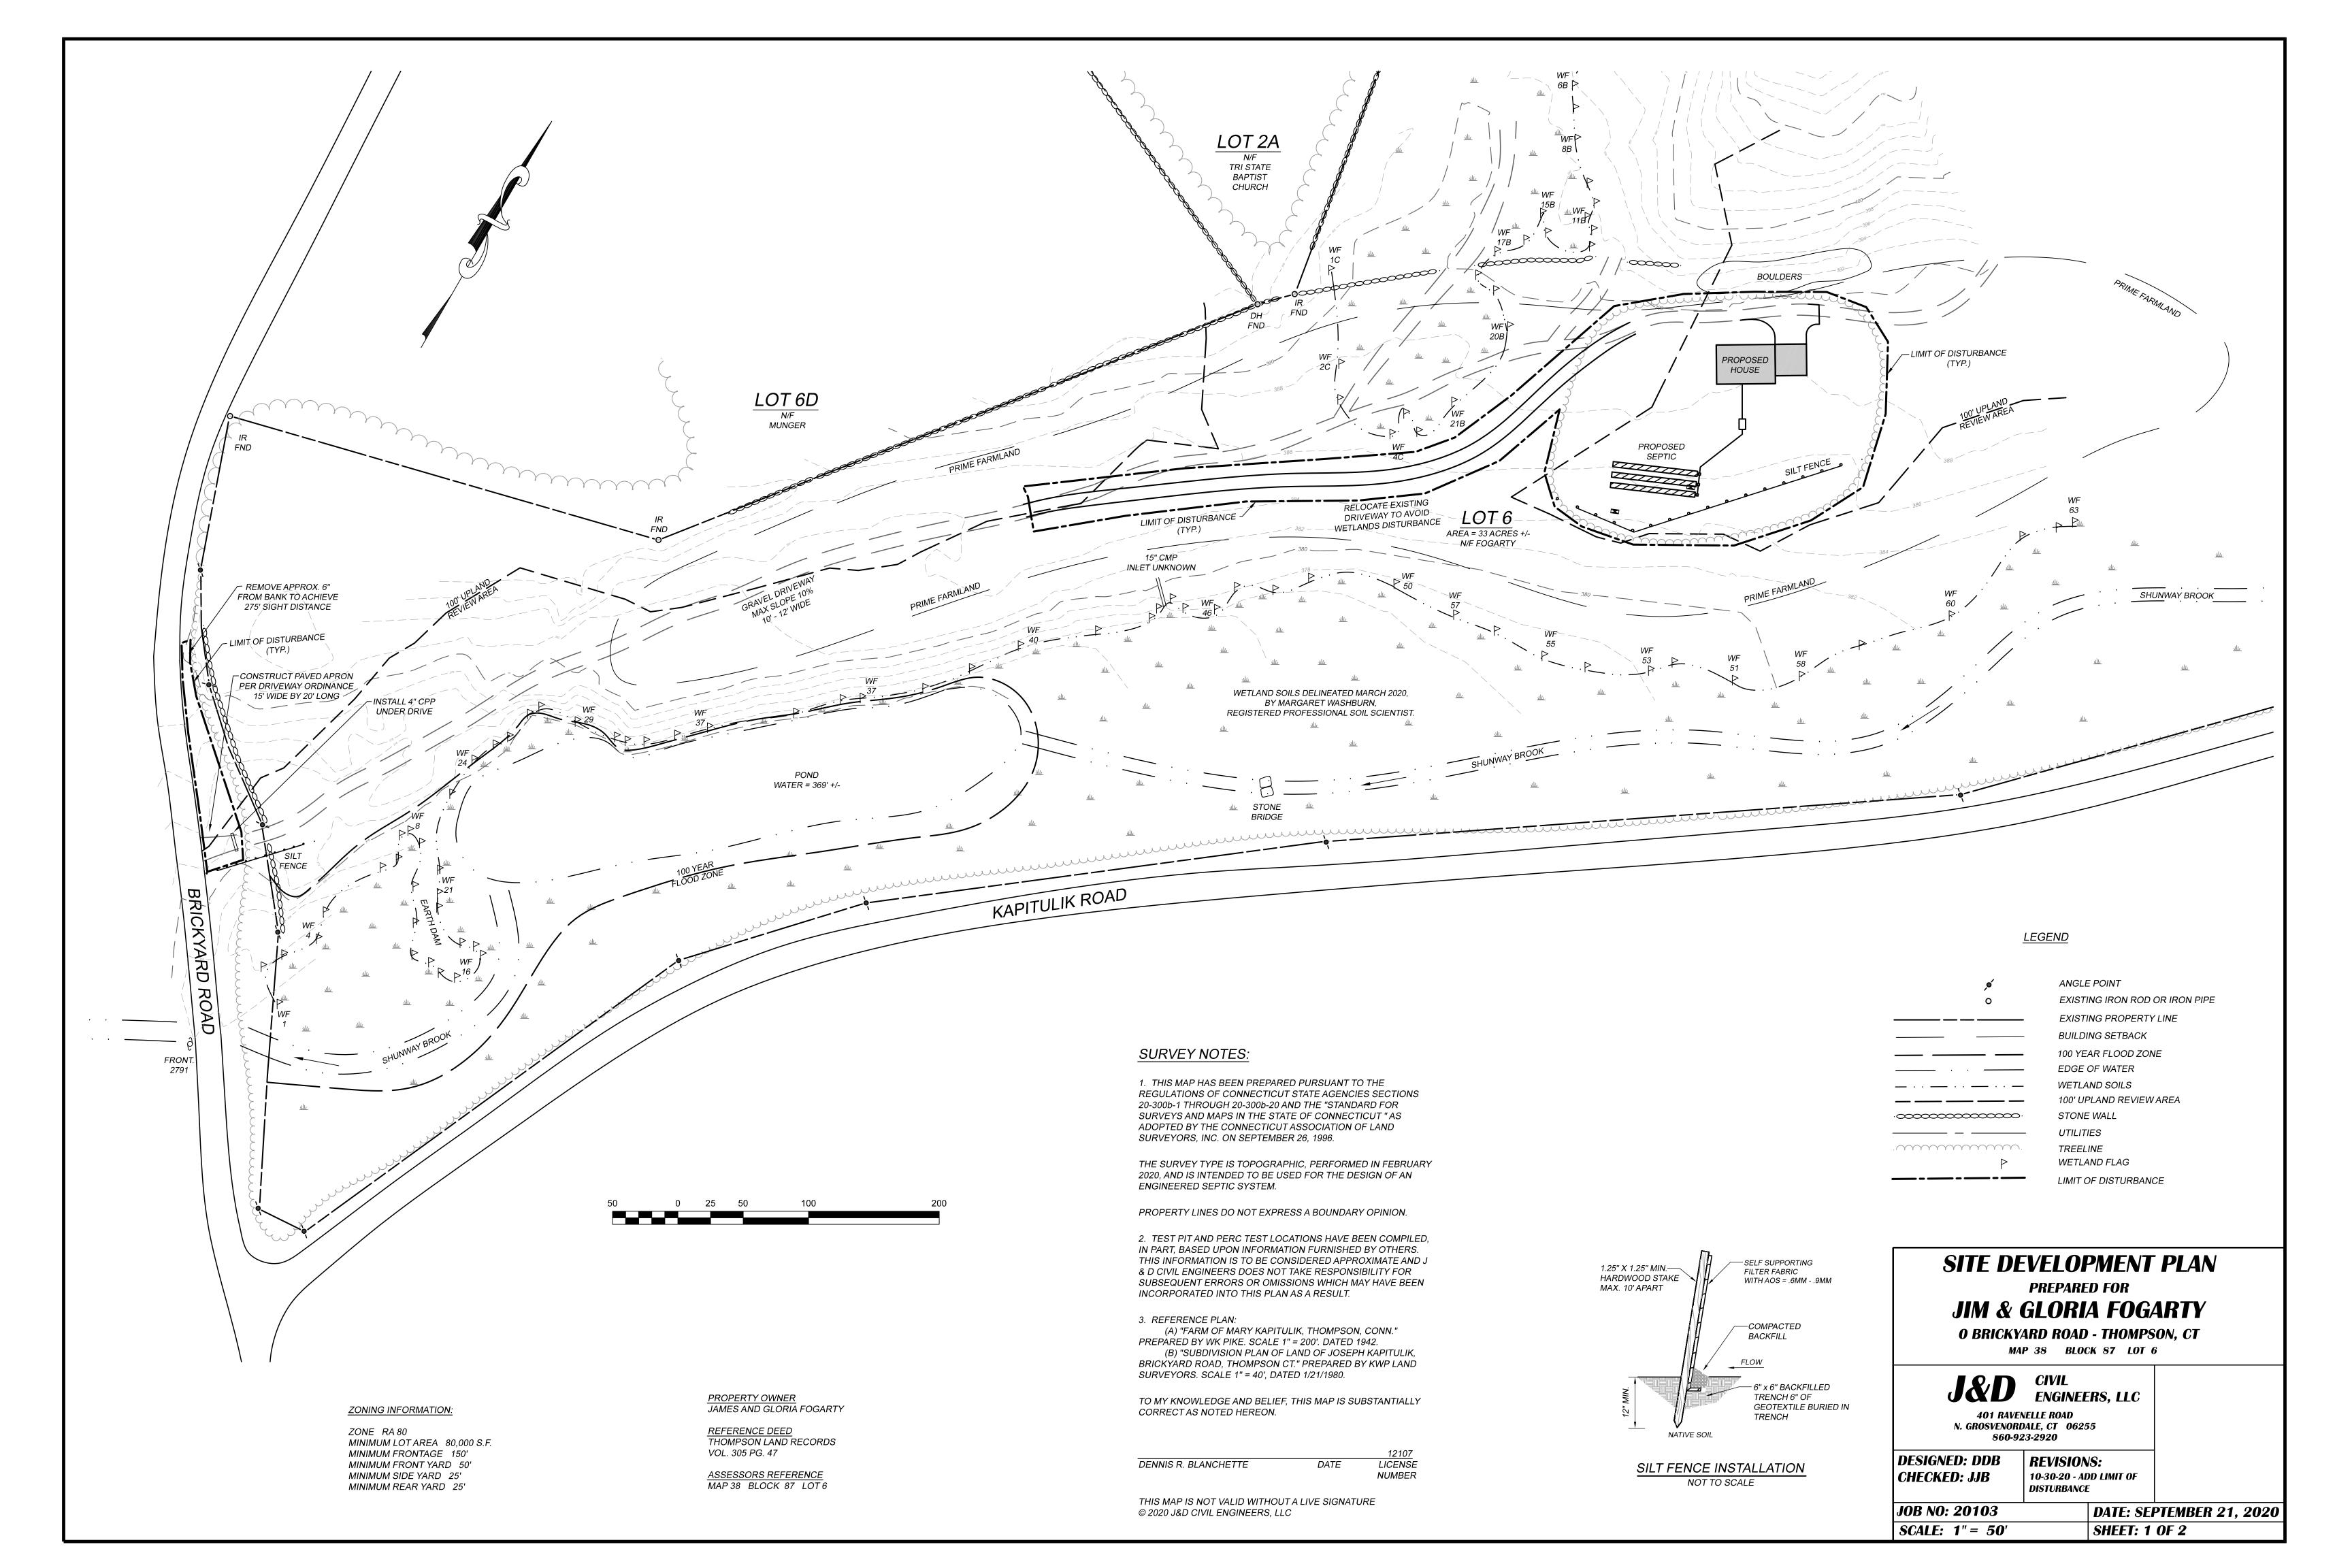

E.c) 1. Applications Received After Agenda was Published

Agenda Item G.a. Violations & Pending Enforcement Actions

Cease & Restore Order VIOL20003 Scott Josey, 637 East Thompson Road, Assessor's map 154, block 5, lot 14: filling of wetlands and work within 100-foot upland review area, issued 3/5/2020, hearing and decision 3/10/2020 soil scientist report submitted 5/10/2020 approved, and to be work completed by 9/15/2020.

Hi Marla,

Looks like the stone across the path filled the crossing. The design was for a 12" deep swale filled with 6" depth of compacted stone on fabric. This would permit overland flow during higher flow periods along with minor discharge through the stone pore areas. I'll talk to Scott to suggest the removal of some excess stone in this area to permit managed overland discharge across the path.

I believe the work completed is a close approximation as designed. Minor fine-tuning is warranted to rectify this situation.

I'll follow-up on this before your meeting and report back.

Thank you,

Roger J. Gibson Jr. PWS, CPESC, Soil Scientist



370 Porter Pond Road Moosup, CT 06354 (860) 836-1081 roger@gibson-environmental.com

From: wetlands@thompsonct.org < wetlands@thompsonct.org >

Sent: Tuesday, October 27, 2020 12:39 PM

To: Gibson Environmental Services < roger@gibson-environmental.com>

Subject: Position on Josey Remediation Work at 637 E. Thompson Rd Cease & Restore Order VIOL20003

Hi Roger,

Attached are some photos I took on October 7, 2020 of Mr. Josey's property at 637 East Thompson Road in Thompson that was the subject of a remediation plan you developed. Could you look at these photos and advise me if this is what your plan intended? The Thompson Inland Wetlands Commission meets on November 10th. If you could let me know what you think of his remediation work by that time it would be most helpful. Thanks for your help. - Marla Butts, Thompson Wetlands Agent

Marla Butts **Thompson Wetlands Agent** 860-923-1852, Ext. 1 wetlands@thompsonct.org

Agenda Item G.b. Violations & Pending Enforcement Actions

VIOL20013, Adrianne Martin and Joseph Fagan, 208 Linehouse Rd, Assessor's map 36, block 70, lot 4, clearcutting of trees and earth moving work in 100-foot upland review area, Notice of Violation issued 5/14/2020 7/14/2020 granted extension to 10/1/2020 for completion of work.

Agenda Item G.c. Violations & Pending Enforcement Actions

VIOL20033, Jennifer Burlingame & Robert Lemieux, Jr., 480 Quaddick Town Farm Rd., Assessor's map 158, block 20, lot 8K, filling / earthmoving within 100-foot upland review area and possibly within delineated wetlands. Notice of Violation issued 8/6/2020 to cease any further earthmoving work and by August 20, 2020 provide an explanation for the earth moving work and the reason why an approval was not sought prior to the initiation of work within 100 feet of delineated wetlands.

Agenda Item G.d. Violations & Pending Enforcement Actions

VIOL20042, Marc Baer, 1227 Thompson Rd., assessor's map 116, block 24, lot 10, revetment construction exceeds scope of work authorized by permit IWA20022, NOV issued 10/29/2020.



Town of Thompson Inland Wetlands Commission

815 Riverside Drive North Grosvenordale, CT 06255 860-923-1852 (Office) 860-923-9897 (Fax)



NOTICE OF VIOLATION

CERTIFIED MAIL

October 29, 2020

Marc S. Baer 344 Nevers Rd South Windsor, CT 06074

RE:

Violation VIOL20042

Noncompliance with & Exceeding Scope of Work Authorized by Permit IWA20022 1227 Thompson Road, Thompson

Assessor's Map 116, Block 24, Lot 10

Dear Mr. Baer,

On October 28, 2020 I conducted an inspection of your property at 1227 Thompson Road, which property is the subject of Inland Wetlands and Watercourses Permit IWA20022. I found the northern terminus of the revetment under construction extending beyond that shown in the approved drawings fill placed in the 100-foot upland review area beyond that shown in the approved drawings. Additionally, portions of the revetment already constructed exceeded the slope of 2:1 maximum as shown in the approved drawings. It was not clear at the time of the inspection if the toe of the revetment had been placed beyond the edge of water identified in the approved drawings as elevation 153.5 ±. Finally, it was reported by your contractor, Patrick Wall, that stone stairs are now proposed to be constructed in the revetment and no stone stairway is shown in the approved drawings. Construction of the revetment has exceeded the scope of work authorized by Permit IWA20022 and exists in violation of section 6 of the Inland Wetlands and Watercourses Regulation of the Town of Thompson.

To avoid further enforcement action please submit to the Wetland Office by November 6, 2020 (1) a drawing of the existing revetment with cross sections every 20 feet signed and sealed by a land surveyor licensed to practice in Connecticut at a scale equal to that of the drawing approved by Permit IWA20022 and (2) a written explanation signed you providing information as to the reason(s) for any discrepancies between the approved drawings and the drawing of the existing revetment.

Failure to comply with this notice may result in the initiation of permit suspension / revocation proceedings and/or the issuance of a Cease and Desist Order, which order would be filed in the permanent land records in the Town of Thompson, and which would encumber your deed until the violation is resolved.

Sincerely

Marla Butts

Wetlands Agent

File: Notice of Violation VIOL20042 Baer 1227 Thompson Rd.doc

cc via email:

Thompson Zoning Enforcement Officer

Thompson Building Office

Northeast District Department of Health

Jamie Fellows, DOT District 2

Daniel Blanchette, J & D Civil Engineering LLC


Patrick Wall, Wall Excavation & Home Improvement LLC










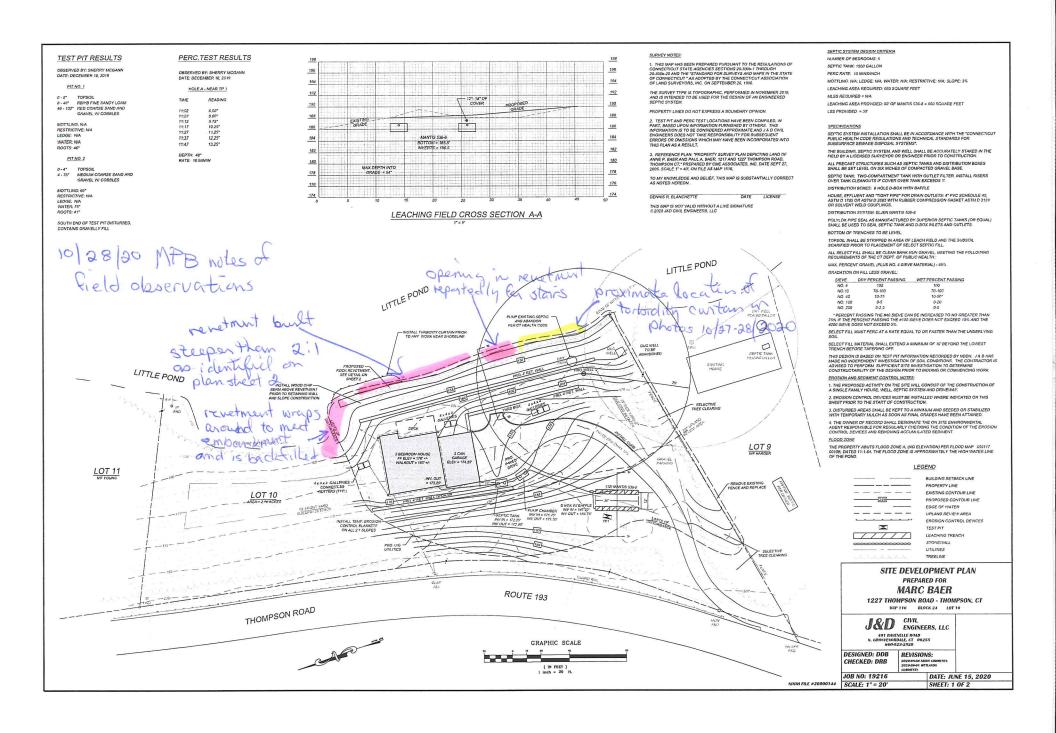

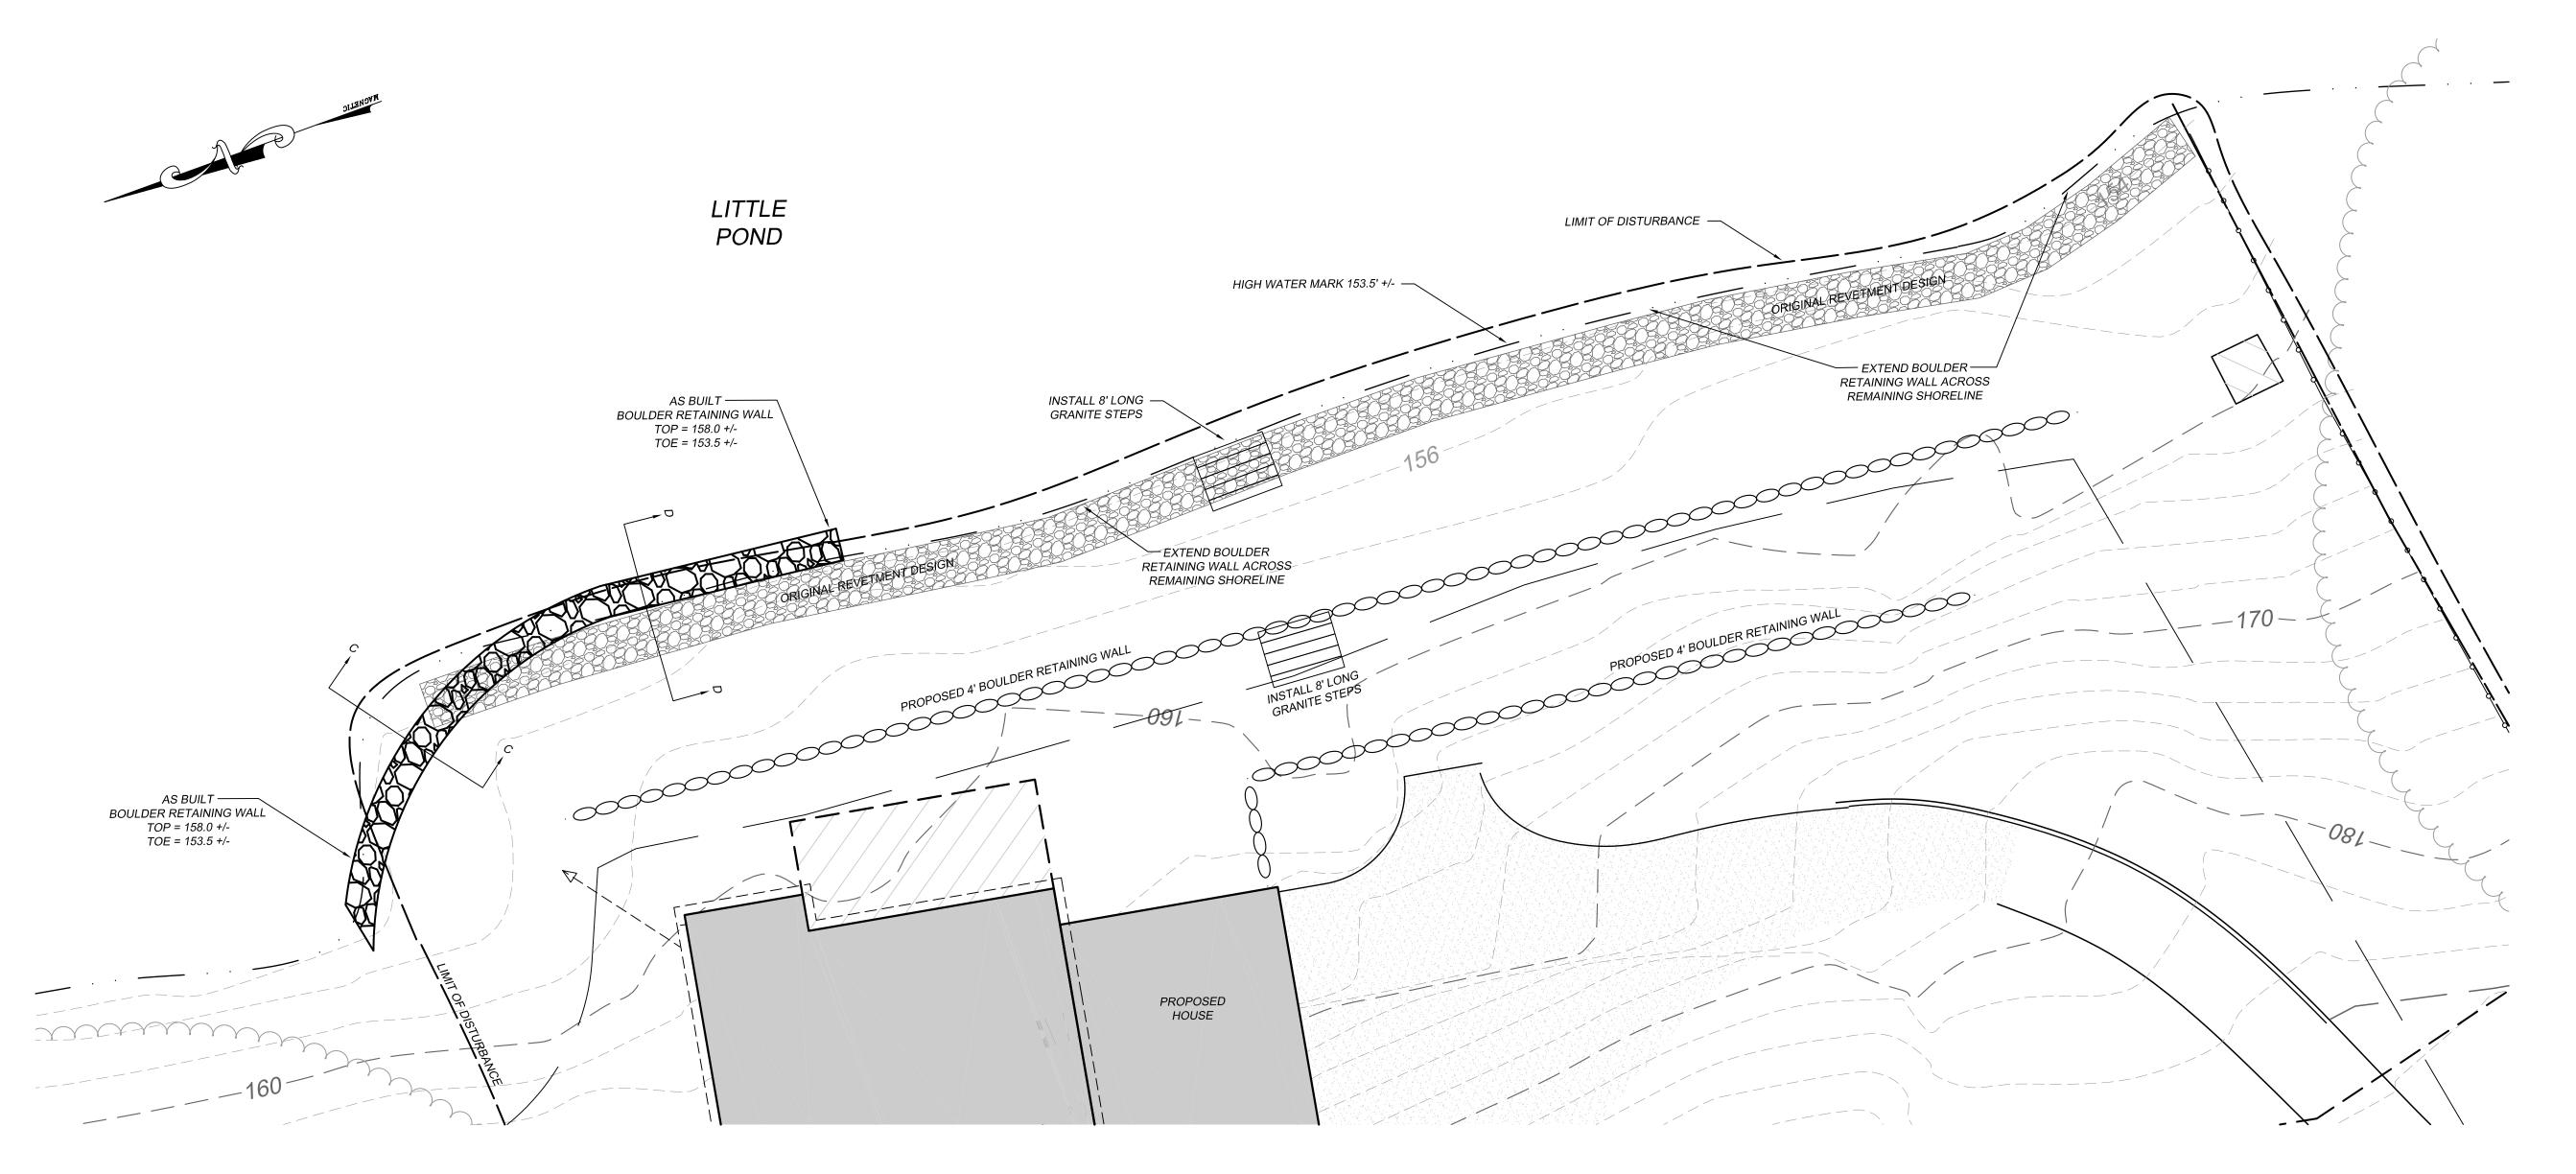

SURVEY NOTES:

1. THIS MAP HAS BEEN PREPARED PURSUANT TO THE REGULATIONS OF CONNECTICUT STATE AGENCIES SECTIONS 20-300b-1 THROUGH 20-300b-20 AND THE "STANDARD FOR SURVEYS AND MAPS IN THE STATE OF CONNECTICUT " AS ADOPTED BY THE CONNECTICUT ASSOCIATION OF LAND SURVEYORS, INC. ON SEPTEMBER 26, 1996.

SURVEY TYPE: GENERAL LOCATION (RETAINING WALL AS BUILT) PERFORMED ON OCTOBER 22, 2020.

ACCURACY: CLASS B, CLASS T2

PROPERTY LINES DO NOT EXPRESS A BOUNDARY OPINION.


2. TEST PIT AND PERC TEST LOCATIONS HAVE BEEN COMPILED, IN PART, BASED UPON INFORMATION FURNISHED BY OTHERS. THIS INFORMATION IS TO BE CONSIDERED APPROXIMATE AND J & D CIVIL ENGINEERS DOES NOT TAKE RESPONSIBILITY FOR SUBSEQUENT ERRORS OR OMISSIONS WHICH MAY HAVE BEEN INCORPORATED INTO THIS PLAN AS A RESULT.

3. REFERENCE PLAN: "PROPERTY SURVEY PLAN DEPICTING LAND OF ANNE P. BAER AND PAUL A. BAER, 1217 AND 1227 THOMPSON ROAD, THOMPSON CT." PREPARED BY CME ASSOCIATES, INC. DATE SEPT 27, 2005. SCALE 1" = 40'. ON FILE AS MAP 1516,


TO MY KNOWLEDGE AND BELIEF, THIS MAP IS SUBSTANTIALLY CORRECT AS NOTED HEREON.

DENNIS R. BLANCHETTE DATE LICENSE

THIS MAP IS NOT VALID WITHOUT A LIVE SIGNATURE © 2020 J&D CIVIL ENGINEERS, LLC

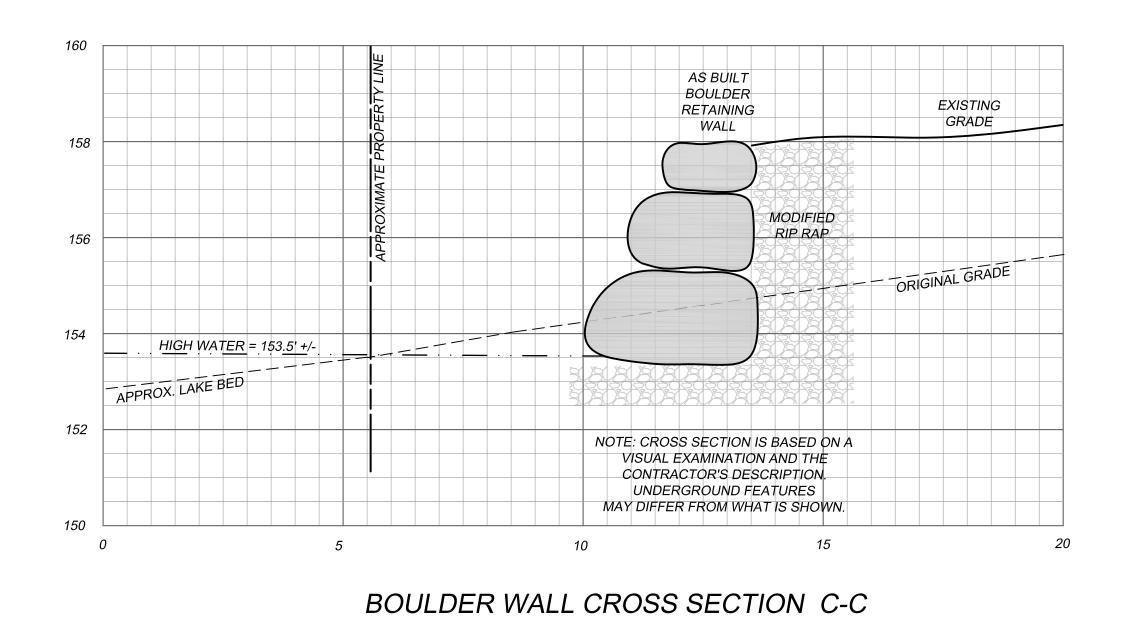

1" = 2'

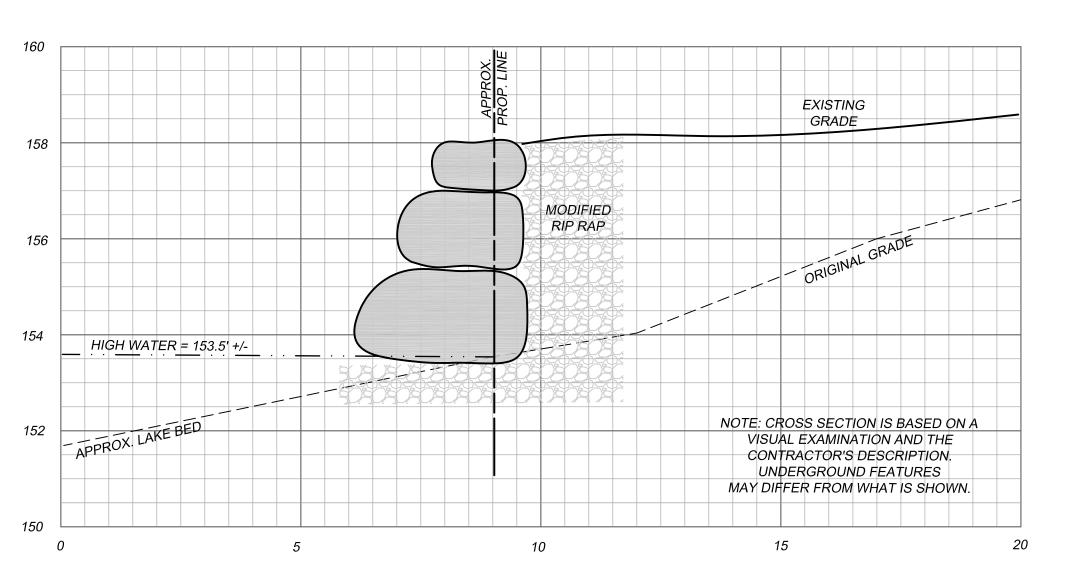

BOULDER WALL CROSS SECTION D-D

<u>LEGEND</u>

BUILDING SETBACK LINE PROPERTY LINE EXISTING CONTOUR LINE PROPOSED CONTOUR LINE EDGE OF WATER UPLAND REVIEW AREA EROSION CONTROL DEVICES

TEST PIT

LEACHING TRENCH STONEWALL ·

UTILITIES TREELINE

RETAINING WALL AS BUILT SURVEY PREPARED FOR MARC BAER

1227 THOMPSON ROAD - THOMPSON, CT

MAP 116 BLOCK 24 LOT 10

J&D CIVIL ENGINEERS, LLC 401 RAVENELLE ROAD N. GROSVENORDALE, CT 06255 860-923-2920

DESIGNED: DDB REVISIONS: CHECKED: DRB

SCALE: 1" = 10'

DATE: NOV 6, 2020 JOB NO: 19216

SHEET: 1 OF 1

Reply Forward Delete

Re: Notice of Violation VIOL20042, Response

Date: 11/06/2020 (02:07:43 PM CST)

From: MARC

To: wetlands@thompsonct.org

Cc: wallexcavation@gmail.com daniel@jdcivilengineers.com smcgann@nddh.org dhall@thompsonct.org

zeo@thompsonct.org



Good Afternoon Marla,

In your letter of 8-21-20 to Daniel Blanchette you stated "Mr. Wall described the construction of the revetment". Mr. Wall, the contractor, has installed the wall/revetment exactly as he explained to you on this date. There was no mention of any questions or concerns as to its construction from your letter.

The revetment was placed, per the contractor, at the waters edge and not beyond it.

In emails to Daniel Blanchette of 8-17-20 and 8-18-20 a set of stairs was mentioned. Apparently this was overlooked when the plans were drawn up and inadvertently left out. This was a mistake but something that was definitely mentioned prior to the construction of

the revetment. Pat Wall also mentioned the stairs and says he spoke with Daniel about them.

Before its construction pictures were sent to the engineer to give him some idea of what the contractor had in mind. Although these could not be an exact representation. The actual appearance of the revetment had to change a little due to the size and shape of the huge rocks being used in its construction. You and the committee saw the size and shape of many of these rocks in pictures presented at some of the wetlands meetings and on your site inspections. These stones had to be fit together much like a puzzle to insure both stability and functionality of the revetment.

The contractor, Pat Wall, has added extra stones in the base of the revetment from the original 6 inches to 2 feet to improve both the strength and function of the wall in order to protect the pond. Daniel Blanchette visited the site and stated to me that the revetment looked good and would function very well. When you visited the site on Oct 28th 2020, with Mr. Obert, you stated to Pat Wall, per Mr. Wall, that the revetment looked good but was not exactly as the plan stated. Sometimes things have to be altered a bit in order to make them better for everyone concerned.

You did have a conversation with Daniel Blanchette after this meeting and appeared to have no problems with him resubmitting new

corrections to the existing plans submitted. To show the changes that were necessary to construct a functional and beautiful revetment. We have tried to be very cooperative in this project and would appreciate your assistance.

Marla i would appreciate it if you are going to have a site inspection, which i welcome you to do, you inform me of the date and time so i can be there to hear exactly what is said and participate. This will keep us all on the same page and keep my costs down. The turbidity curtain cost me an extra \$671.00. And this is just one small cost that i have had to endure because of the nonsense my neighbors are causing. You will note i did go to the first site inspection and was very easy to get along with even if my neighbors could not make up their minds as to what they actually wanted done. I have tried my best to be open minded and cooperate in an attempt to be a good citizen of Thompson.

Being disabled this process has effected me in three areas: physically, mentally and financially. I am only asking to be treated fairly and not subjected to excessive demands and requirements unless you are going to subject everyone to the same demands.

As a side note the Hargers have been attempting to dump debris on both my properties at 1227 and 1232 Thompson road. They were caught and spoken to by the contractor, Pat Wall. He asked them to cease this illegal activity. Do you or any of the good town people have any suggestions how to deal with this? I am enclosing a picture showing a small pile of leaves the Hargers pushed onto my property which is a straight line following the fence line about two feet into the black area of the driveway.

I am also sending you the pictures which were sent to the engineer from the contractor, Pat Wall, attempting to give some idea of the appearance of the revetment.

Thanks for your cooperation.

Sincerely yours,

Dr. Marc S. Baer

----Original Message-----

From: wetlands@thompsonct.org

To: Marc Baer <marcmason1054@cs.com>; Patrick Wall <wallexcavation@gmail.com>; Daniel Blanchette <daniel@jdcivilengineers.com>; Sherry McGann <smcgann@nddh.org>; Donna Hall, Building Office

<dhall@thompsonct.org>; Cynthia Dunne, ZEO <zeo@thompsonct.org>

Cc: Amy St.Onge, 1st Selectman selectman@thompsonct.org; H. Charles Obert, IWC Vice Chair <cobert@thompsonct.org; George O'Neil, IWC Chair <goneil3@thompsonct.org; Fran Morano, IWC Commissioner <fmorano44@gmail.com; Diane Chapin, IWC Treasurer <dchapin@thompsonct.org; Barbara Roach, IWC Alternate

Sent: Thu, Oct 29, 2020 2:35 pm

Subject: Notice of Violation VIOL20042 Baer 1227 Thompson Rd, Noncompliance with & Exceeding Scope of Work Authorized by Permit IWA20022

Please see attached. Marla Butts

--

Marla Butts
Thompson Wetlands Agent

Agenda Item H Other Business

a) Schedule of Meetings for Calendar Year 2021



Town of Thompson Inland Wetlands Commission

815 Riverside Drive North Grosvenordale, CT 06255 860-923-1852 Office email: wetlands@thompsonct.org



Memo

To: Renee Waldron, Thompson Town Clerk

From: Marla Butts, Thompson Wetlands Agent

Date: November 15, 2020

Re: Thompson Inland Wetlands Commission Listing of Meetings for 2021

In accordance with §1-225(b) of the Connecticut General Statutes and the Thompson Inland Wetlands Commission By-Laws below is a listing of the Thompson Inland Wetlands Commission's schedule of the regular meetings for 2021.

The following meetings are planned for 7 p.m. and based upon Covid 19 pandemic requirements via ZOOM or in the Merrill Seney Community Room at the Town Hall.

Tuesday, January 12
Tuesday, February 9
Tuesday, March 9
Tuesday, April 13
Tuesday, May 11
Tuesday, June 8
Tuesday, July 13
Tuesday, August 10
Tuesday, September 14
Tuesday, October 12
Tuesday, November 9
Tuesday, December 14

Site walks are scheduled meetings not required by town ordinance, Inland Wetlands Commission regulation or by-law. While site walks are frequently cancelled, they are planned for 9 a.m. at the specified location (s) in the posted meeting agenda.

Saturday, January 9

Saturday, February 6

Saturday, March 6

Saturday, April 10

Saturday, May 8

Saturday, June 5

Saturday, July 10

Saturday, August 7

Saturday, September 11

Saturday, October 9

Saturday, November 6

Saturday, December 11



ary 2021

February 2021

2021 US CALENDAR WITH HOLIDAYS

April 2021

May 2021

March 2021



June 202

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USA Holidays and Observances									
Jan 01	New Year's Day	Jan 18	M L King Day	Feb 14	Valentine's Day				
Feb 15	Presidents' Day	Apr 02	Good Friday	Apr 04	Easter Sunday				
May 09	Mother's Day	May 31	Memorial Day	Jun 04	National Donut Day				
Jun 20	Father's Day	Jul 04	Independence Day	Jul 05	Independence Day Holiday				
Sep 06	Labor Day	Oct 11	Columbus Day	Oct 31	Halloween				
Nov 11	Veterans Day	Nov 25	Thanksgiving Day	Dec 25	Christmas				

Feb 12 Lincoln's Birthday calendar 2021i.com

Recognized Holidays

Agenda Item H Other Business

b) DOT Notification on submittal of DEEP permit application for rehabilitation of bridge # 06794 on I-395 over unnamed brook.

STATE OF CONNECTICUT



DEPARTMENT OF TRANSPORTATION



2800 BERLIN TURNPIKE, P.O. BOX 317546 NEWINGTON, CONNECTICUT 06131-7546

TO: Thompson Planning & Zoning Commission

815 Riverside Drive

PO Box 899

North Grosvenordale, CT 06255

Robert E. Bell Robert Bell Digitally signed by Robert Bell Object 2020, 10,22 08,29,49 FROM:

Transportation Planning Director Bureau of Policy and Planning

SUBJECT: Notification of Submittal of Application to the State of Connecticut, Department of

Energy and Environmental Protection's (DEEP) for a General Permit for Water

Resource Construction Activities

PROJECT: State Project No. 0141-0154

Rehabilitation of Bridge No. 06793, I-395 over Little Mountain Brook

Town of Thompson

Enclosed is a copy of our Request for Authorization under the State of Connecticut Department of Energy and Environmental Protection's General Permit for Water Resources Construction Activities. If your agency wishes to comment on the enclosed application, comments must be submitted to the State Department of Energy and Environmental Protection.

Comments should be directed to:

Land and Water Resources Division Department of Energy and Environmental Protection 79 Elm Street Hartford, CT 06106-5127

If we can provide additional information, please contact Mr. Jason M. Coite at 860-594-3448.

STATE OF CONNECTICUT



DEPARTMENT OF TRANSPORTATION



2800 BERLIN TURNPIKE, P.O. BOX 317546 NEWINGTON, CONNECTICUT 06131-7546

TO: Thompson Inland Wetlands Commission

815 Riverside Drive

PO Box 899

North Grosvenordale, CT 06255

FROM: Robert E. Bell Robert Bell Digitally signed by Robert Bell Date: 2020.10.22 08:30:19

Transportation Planning Director Bureau of Policy and Planning

SUBJECT: Notification of Submittal of Application to the State of Connecticut, Department of

Energy and Environmental Protection's (DEEP) for a General Permit for Water

Resource Construction Activities

PROJECT: State Project No. 0141-0154

Rehabilitation of Bridge No. 06793, I-395 over Little Mountain Brook


Town of Thompson

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Land and Water Resources Division
Department of Energy and Environmental Protection
79 Elm Street
Hartford, CT 06106-5127


If we can provide additional information, please contact Mr. Jason M. Coite at 860-594-2157.



GENERAL NOTES:

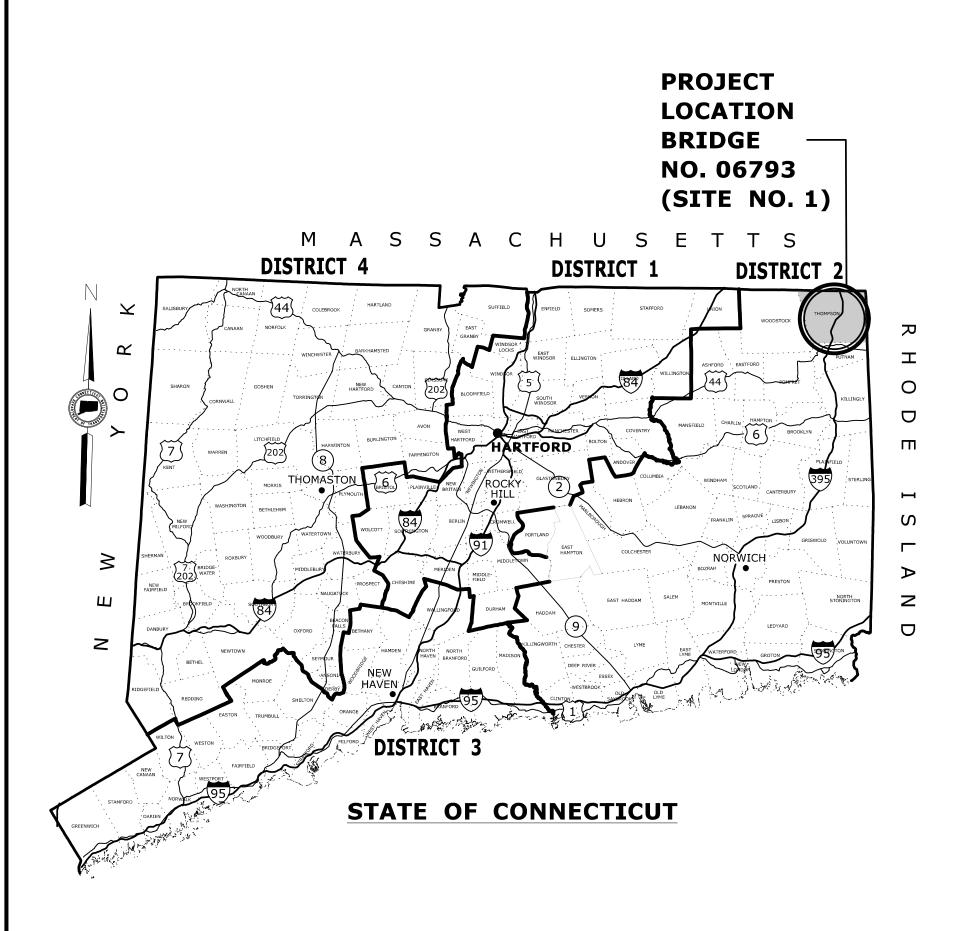
- 1. THESE PLANS ARE INTENDED ONLY FOR ENVIRONMENTAL PERMITTING PURPOSES. THESE PLANS HOLD AUTHORITY FOR ALL ACTIVITIES CONCERNING THE REGULATED AREA. FOR DETAILED PLANIMETRIC INFORMATION AND PAYMENT REFER TO THE APPLICABLE CONTRACT DOCUMENTS.
- 2. THE DEPARTMENT OF TRANSPORTATION WILL ONLY SUBMIT REVISIONS TO DEEP AND USACE FOR CHANGES TO THE DESIGN THAT WILL AFFECT REGULATED AREAS.
- 3. FOR A DESCRIPTION OF THE WATERCOURSES, WETLANDS AND WETLAND SOILS SEE RELEVANT SECTIONS OF THE PERMIT APPLICATION.
- 4. 400 FOOT GRID BASED ON CONNECTICUT COORDINATE SYSTEM N.A.D. 1983 VERTICAL DATUM BASED ON N.A.V.D. OF 1988.
- 5. ALL CONSTRUCTION ACTIVITIES WILL BE CONDUCTED IN ACCORDANCE WITH THE DEPARTMENT'S STANDARD SPECIFICATIONS FOR ROADS, BRIDGE, AND INCIDENTAL CONSTRUCTION, FORM 817, SECTION 1.10 AND WILL ALSO FOLLOW "REQUIRED" BEST MANAGEMENT PRACTICES (BMPs) AND SEDIMENT AND EROSION CONTROL MEASURES IN ACCORDANCE WITH THE 2002 EROSION & SEDIMENTATION CONTROL GUIDELINES AND THE 2004 STORMWATER QUALITY MANUAL.

ENVIRONMENTAL PERMIT PLANS STATE PROJECT NO. 141-154 REHABILITATION OF BRIDGE NO. 06793 I-395 OVER LITTLE MOUNTAIN BROOK (SITE NO. 1) IN THE TOWN OF THOMPSON

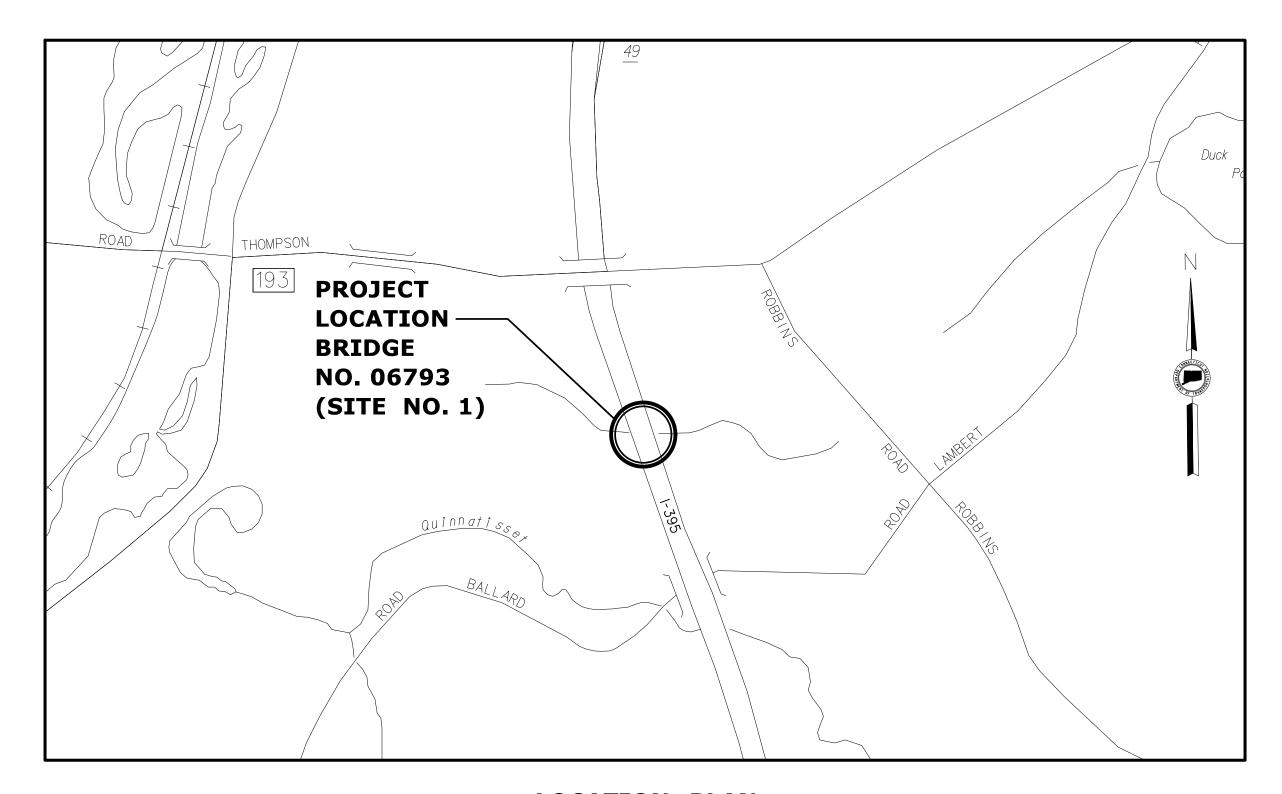

SCALE: 1" = 500'

	LIST OF DRAWINGS
DRAWING NO.	DRAWING TITLE
PMT-01	TITLE SHEET
PMT-02	GENERAL PLAN
PMT-03	WETLAND/WATERCOURSE IMPACT PLAN
PMT-04	LONGITUDINAL SECTION AND ELEVATIONS
PMT-05	WATER HANDLING PLAN
PMT-06	MISCELLANEOUS DETAILS
PMT-07	RESTORATION PLANTING PLAN

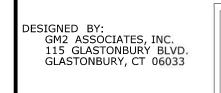






Jagdeesh Gopal 2019.07.19 14:35:30-04'00'


ENVIRONMENTAL PERMIT PLANS - 7/8/19

THE INFORMATION, INCLUDING ESTIMATED QUANTITIES OF WORK, SHOWN ON THESE SHEETS IS BASED ON LIMITED INVESTIGATIONS BY THE STATE AND IS IN NO WAY WARRANTED TO INDICATE THE CONDITIONS OF ACTUAL QUANTITIES OF WORK WHICH WILL BE REQUIRED. DESIGNER/DRAFTER: SKS CHECKED BY: JG SCALE AS NOTED	STATE OF CONNECTICUT DEPARTMENT OF TRANSPORTATION	SIGNATURE/ BLOCK: GM2 ASSOCIATES, INC. 115 GLASTONBURY BLVD. GLASTONBURY, CT 06033	REHABILITATION OF BRIDGE NO. 06793 I-395 OVER LITTLE MOUNTAIN BROOK	THOMPSON DRAWING TITLE: TITLE SHEET	PROJECT NO. 141-154 DRAWING NO. PMT-01 SHEET NO.
PEV DATE PEVISION DESCRIPTION SHEET NO Plotted Date: 7/19/2019	Filename: NHW MSH 141 154 TSH dan				

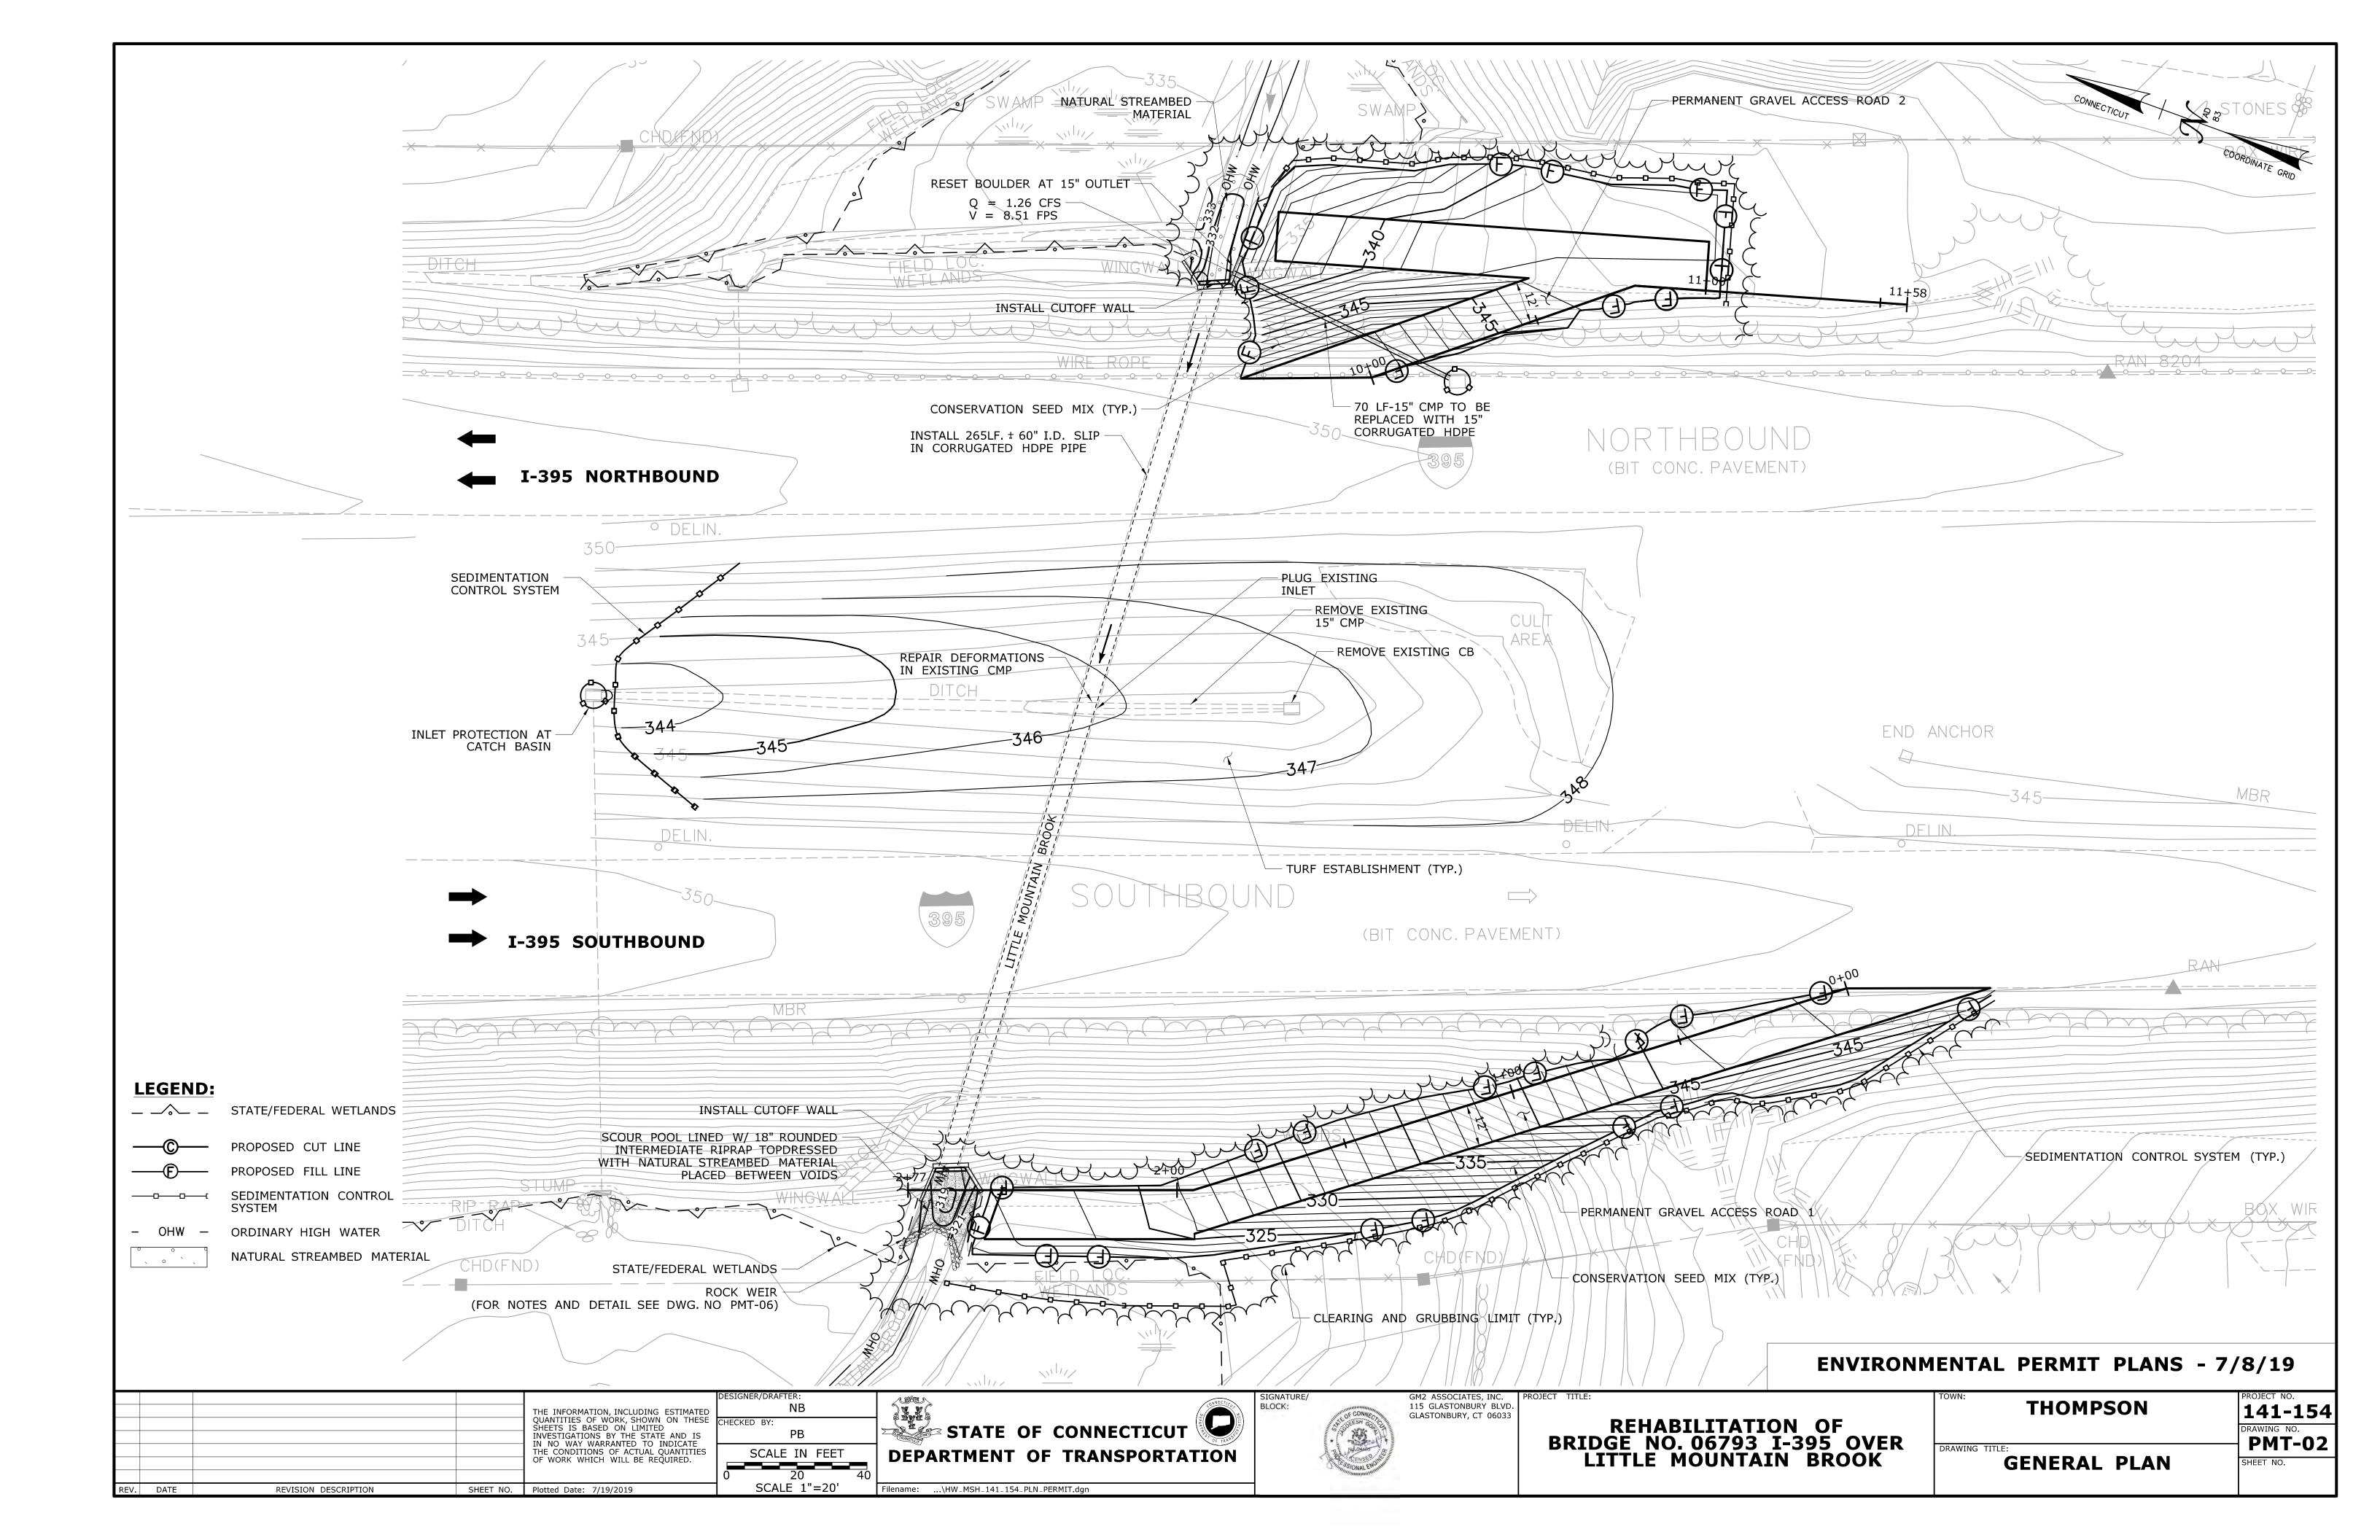

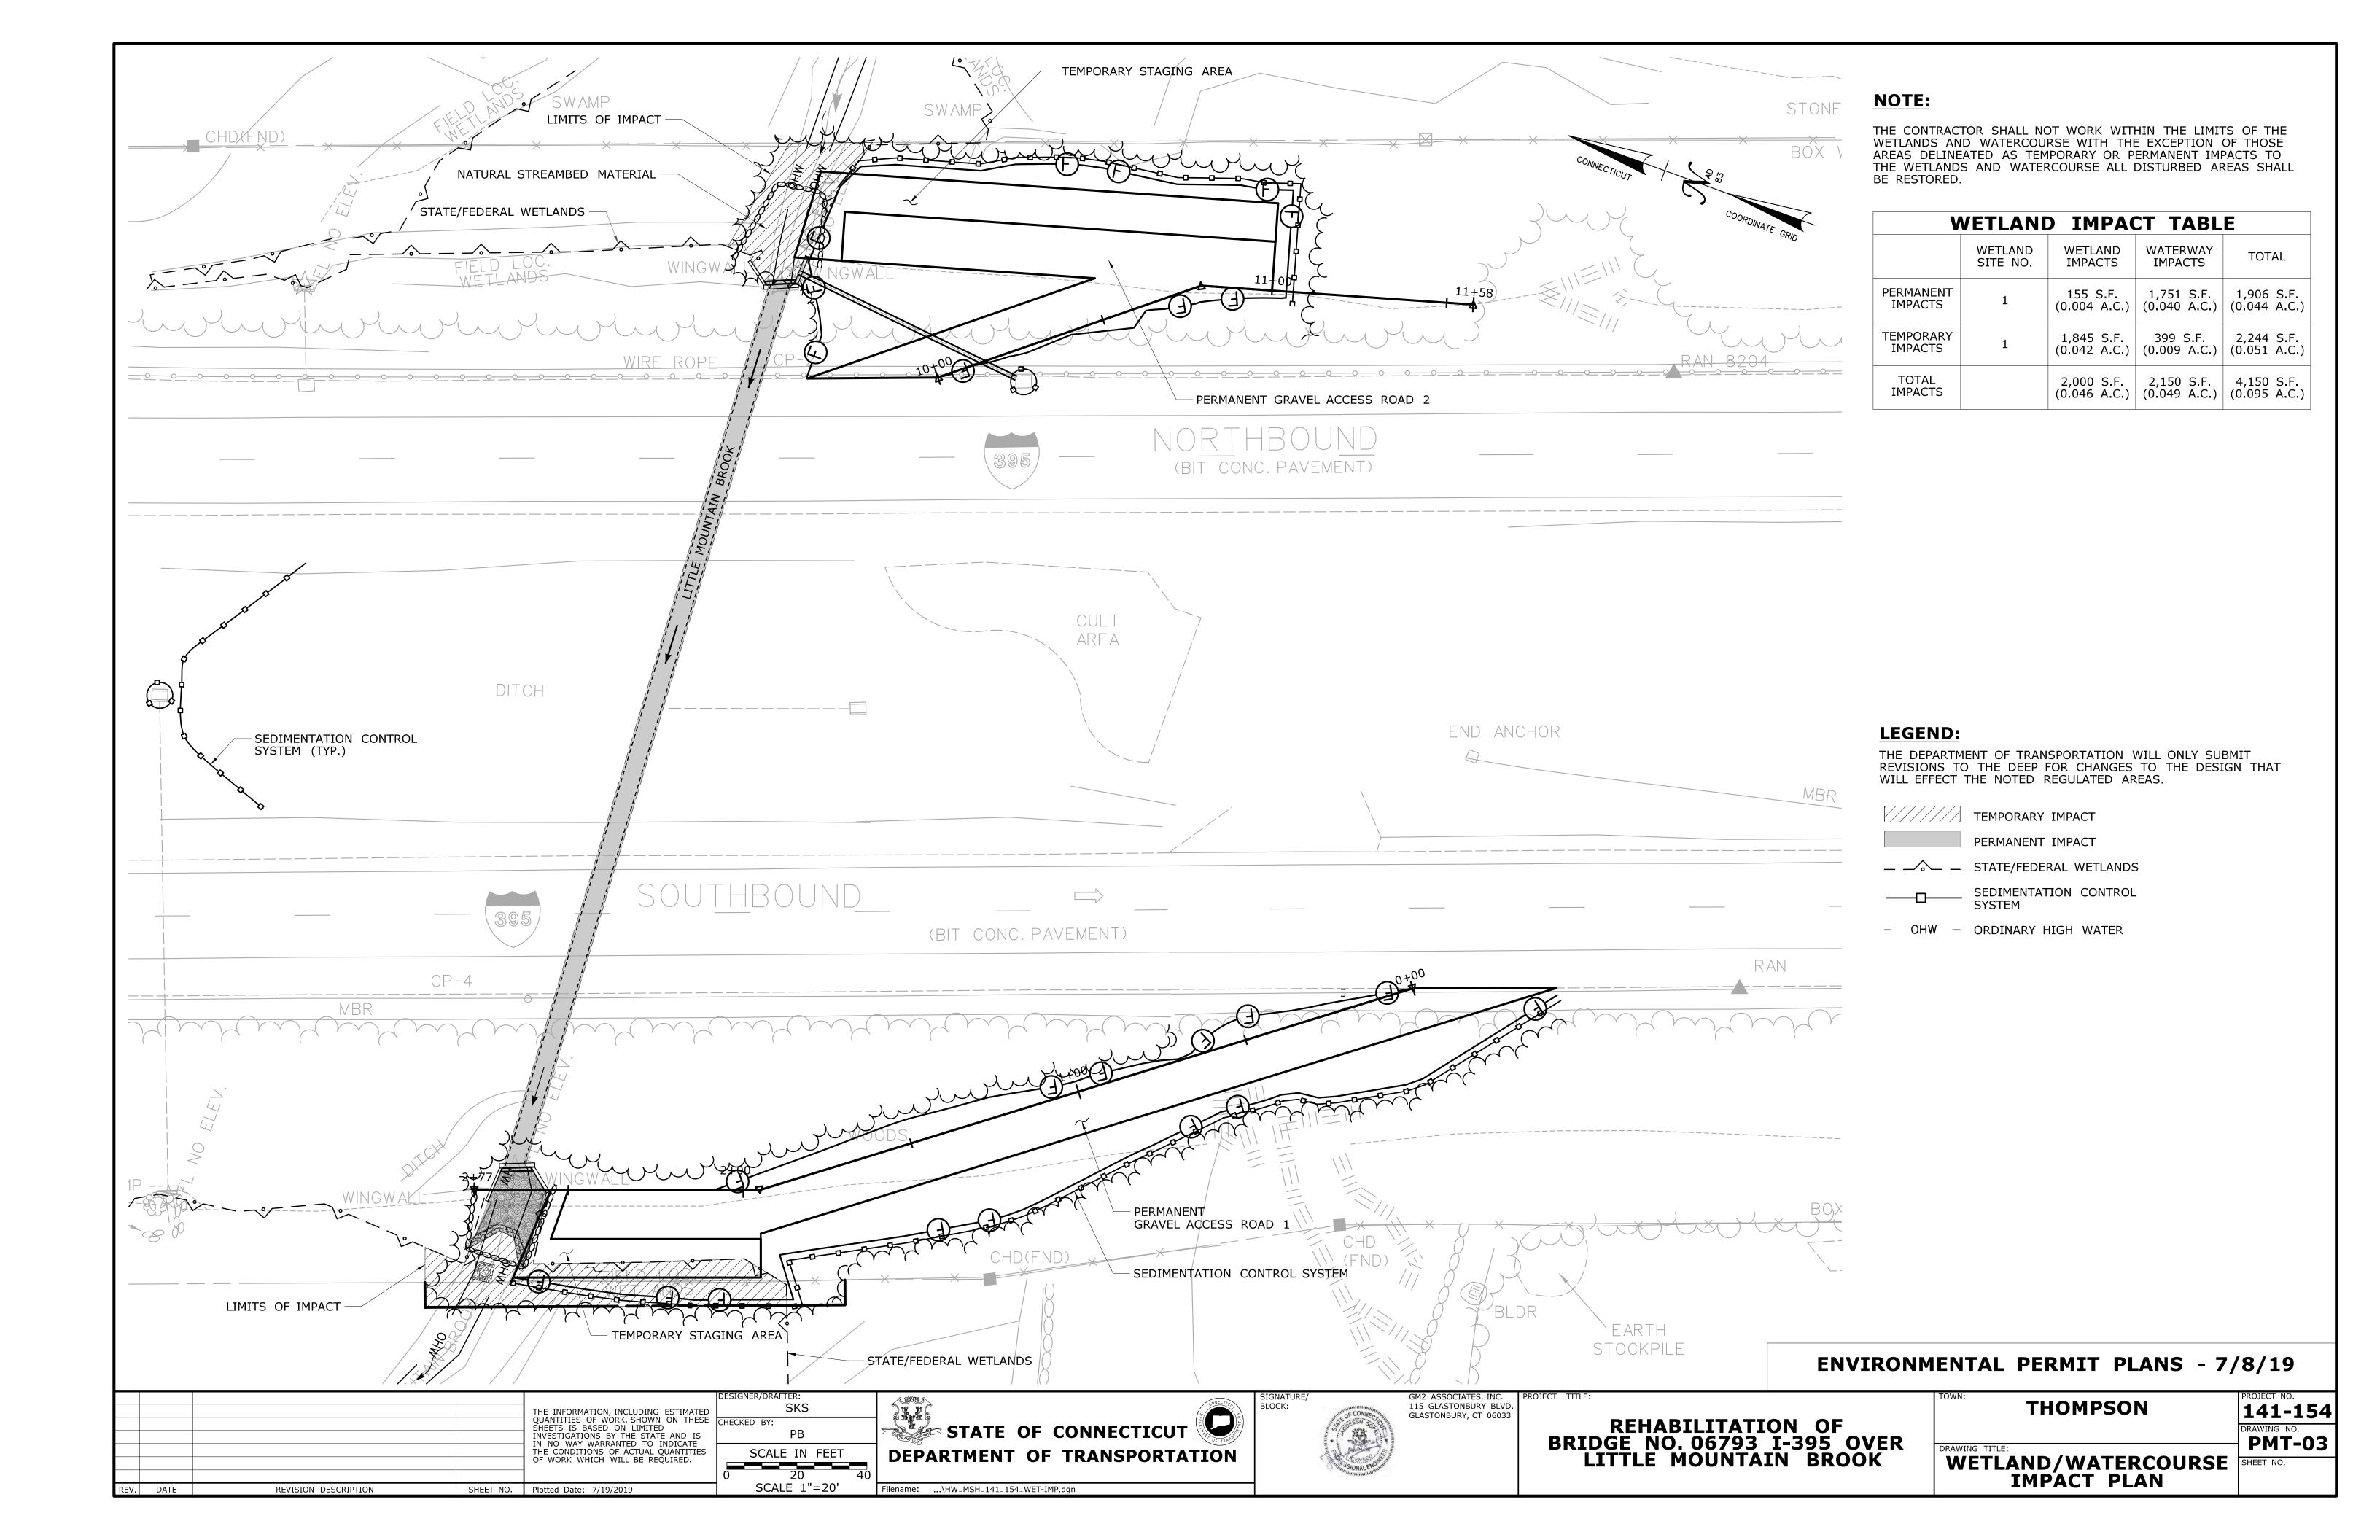

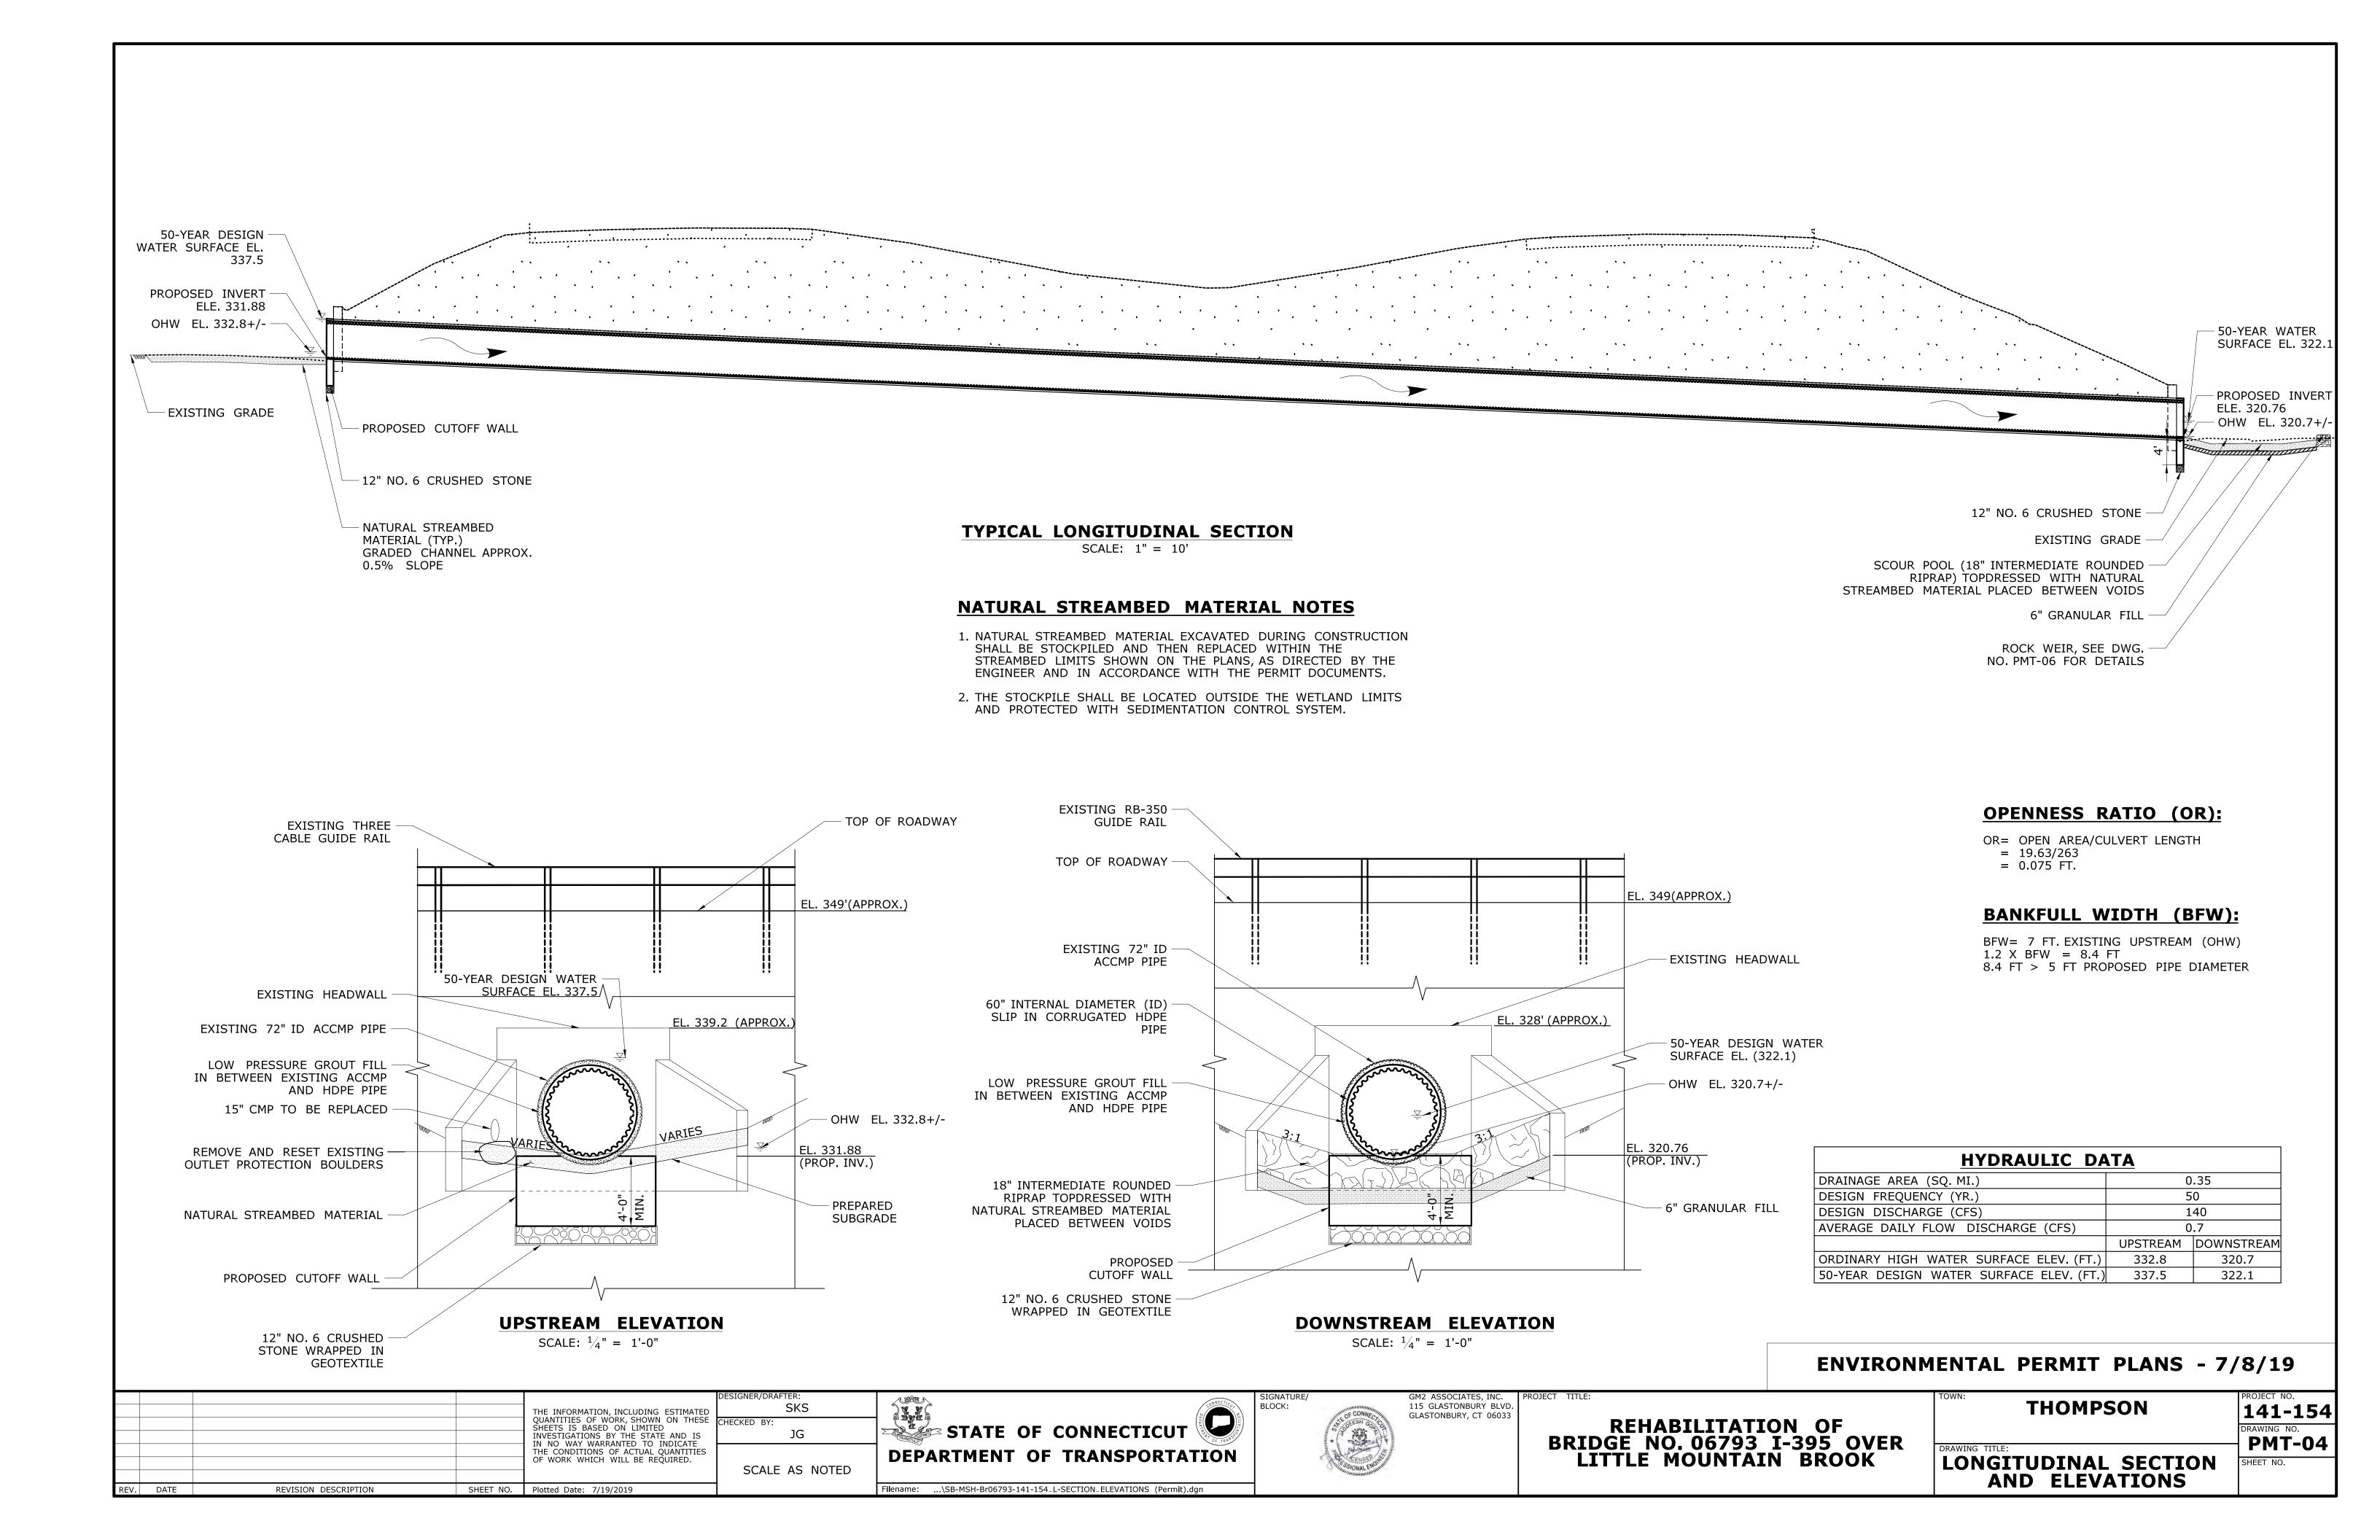

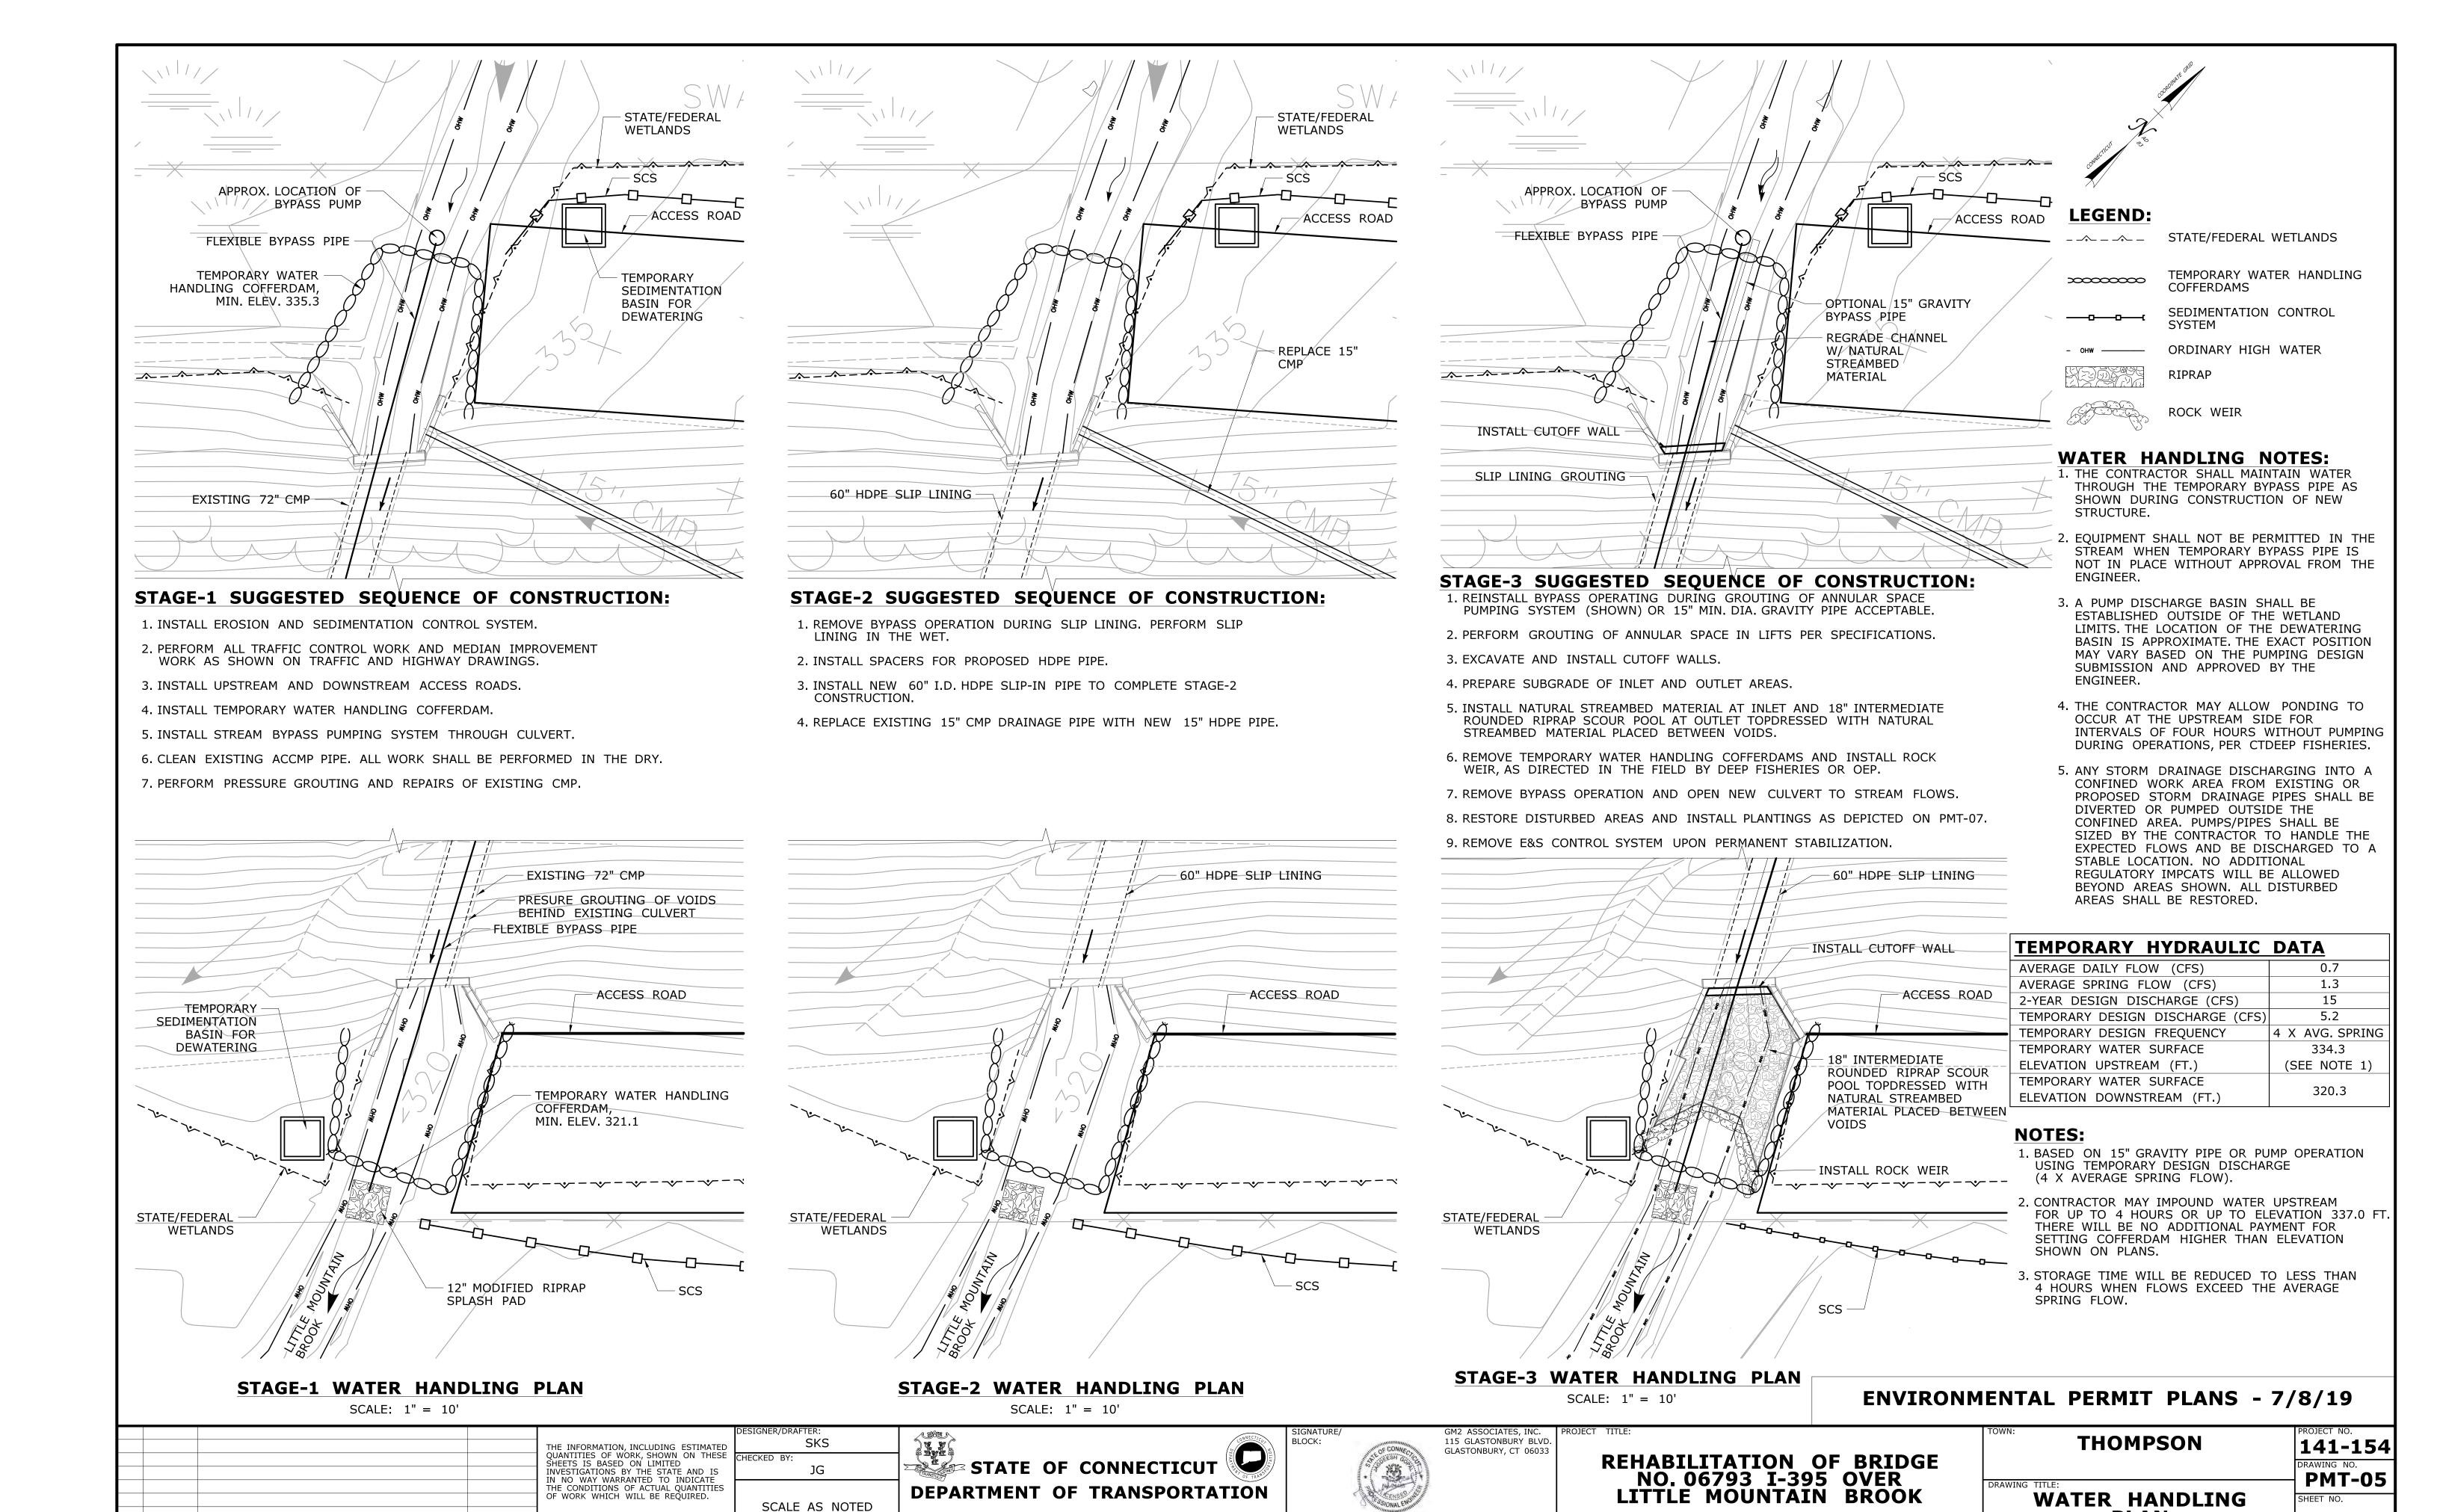


Filename: ...\SB-MSH-Br06793-141-154_WH PLAN.dan

SHEET NO. Plotted Date: 7/19/2019

REVISION DESCRIPTION

REV. DATE

PLAN

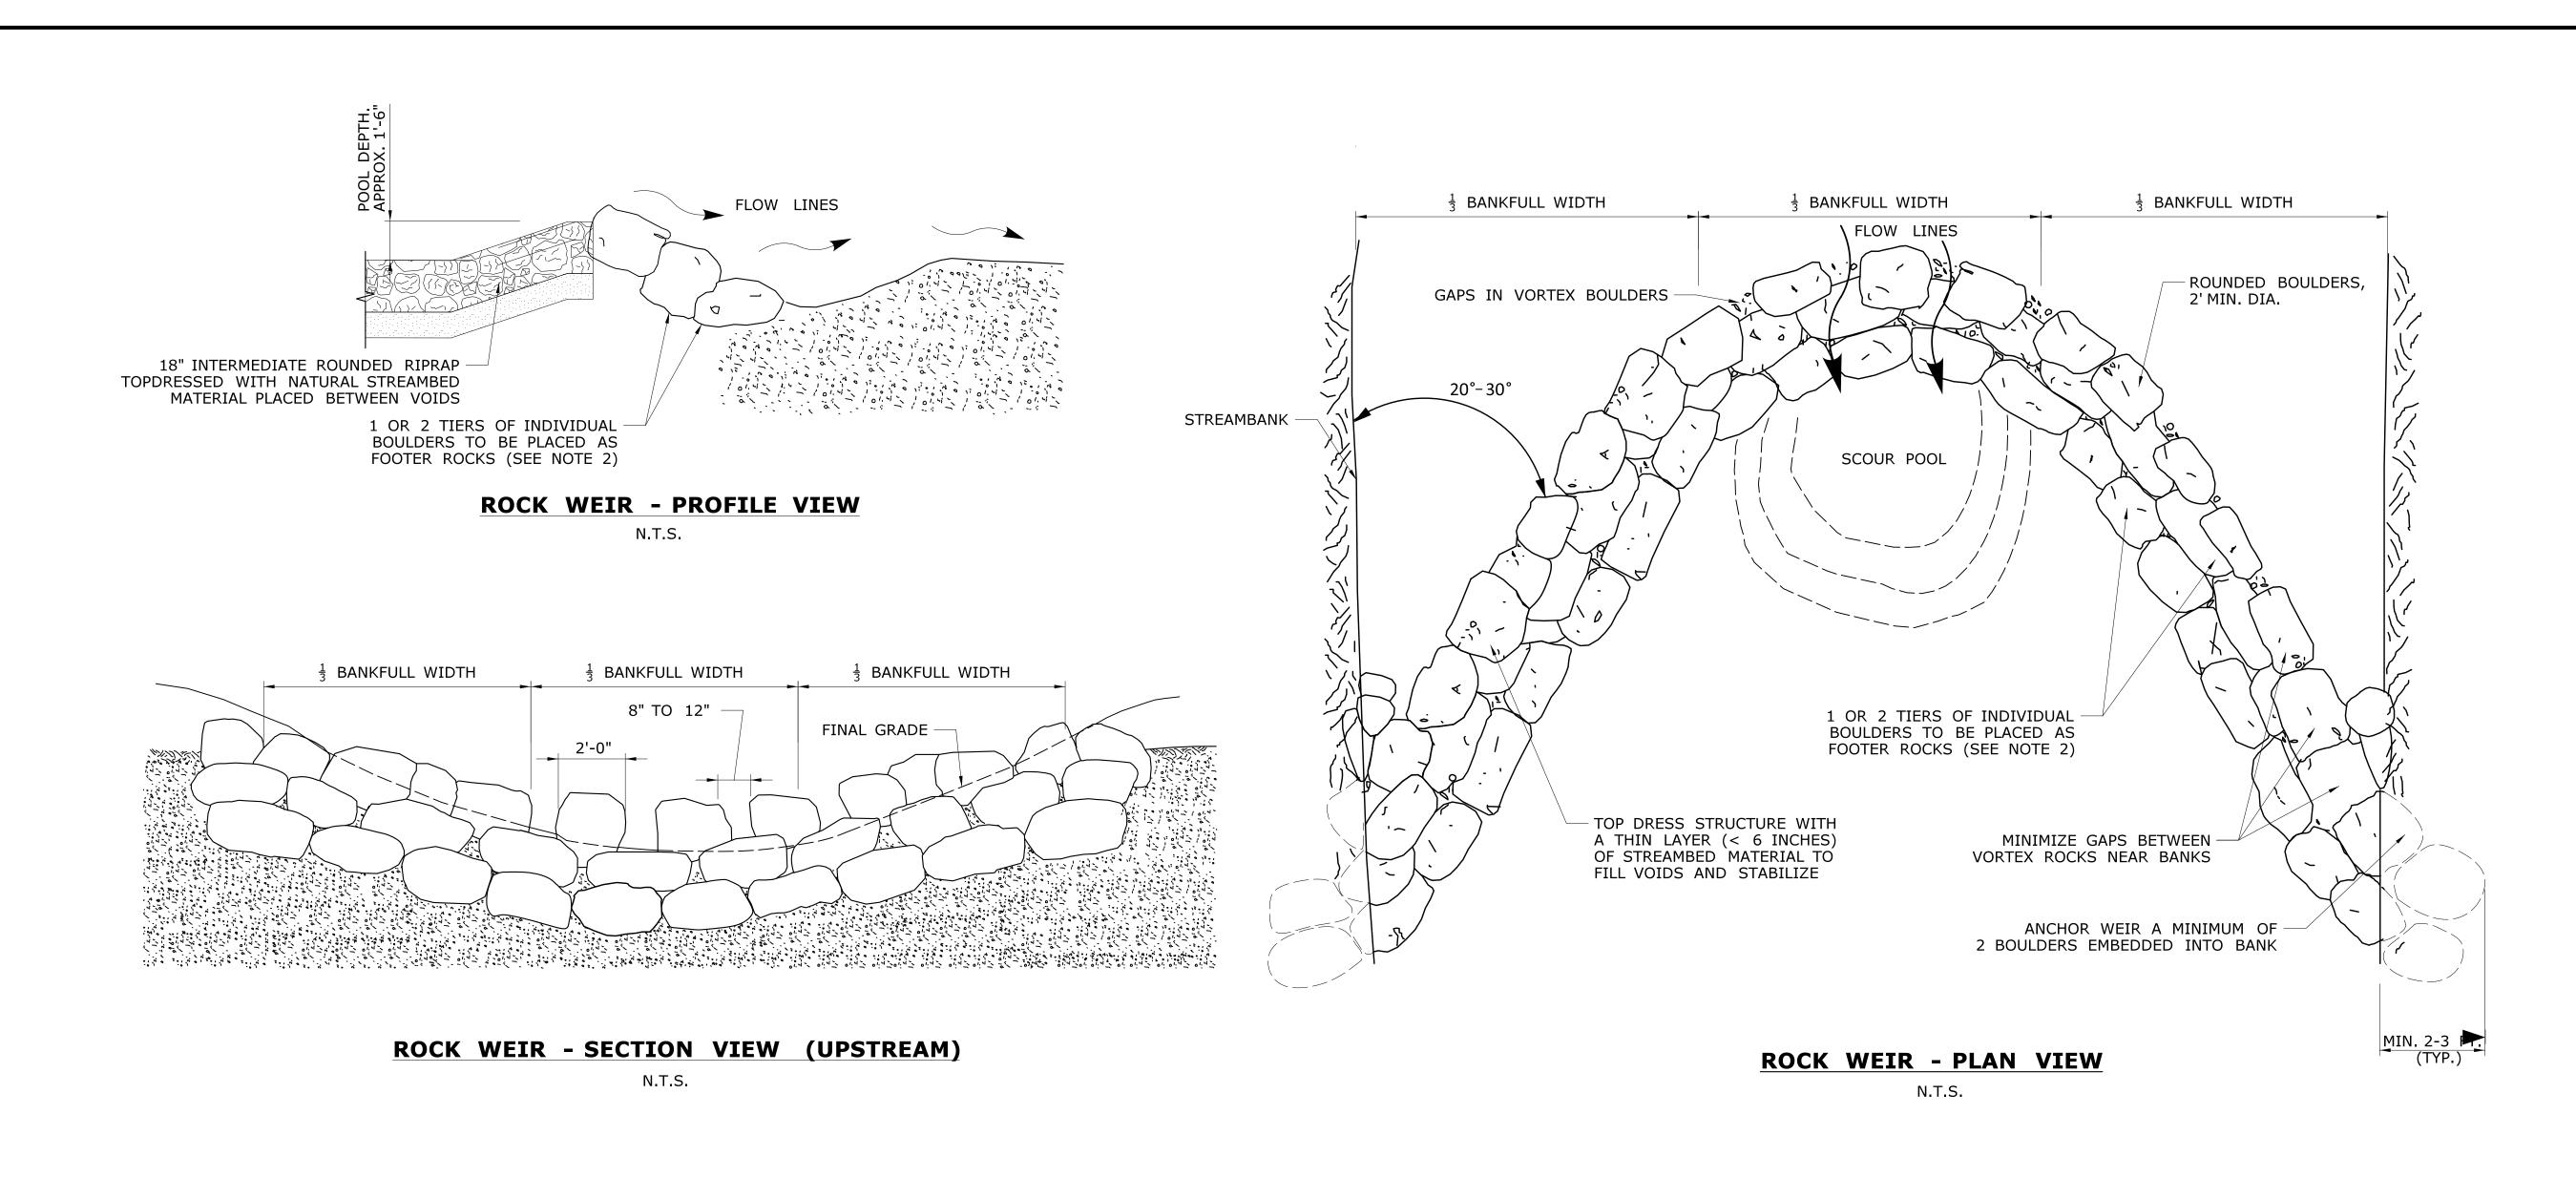

ROCK WEIR NOTES:

- 1. PLACEMENT OF THE ROCK WEIR SHALL BE DIRECTED IN THE FIELD BY CTDEEP FISHERIES OR THEIR AUTHORIZED DELEGATE. SEE SPECIAL PROVISION "ROCK WEIR".
- 2. FOOTER ROCKS SHALL SERVE AS THE FOUNDATION FOR THE TOP LAYER OF THE WEIR. FOOTER ROCKS SHALL HAVE REASONABLE FLAT TOPS AND BOTTOMS TO ENABLE BETTER PLACEMENT OF THE TOP LAYER OF THE WEIR.

NOTES:

- 1. CONTRACTOR IS RESPONSIBLE FOR ANY ADDITIONAL ACCESS LAYOUT AND IMPLEMENTATION NEEDED FOR THE SHOWN ACCESS ROADWAYS AS REQUIRED TO COMPLETE THE WORK. NO ENCROACHMENT INTO EXISTING LITTLE MOUNTAIN BROOK, STREAMS, WATERWAYS OR WETLAND AREAS OTHER THAN THAT SHOWN HEREON WILL BE ALLOWED.
- 2. ALL DISTURBED AREA TO BE REESTABLISHED WITH TURF ESTABLISHMENT AND SEEDING AS SHOWN ON PLANS OR AS DIRECTED BY THE ENGINEER.
- 3. SLOPE LIMITS ARE APPROXIMATE AND MAY CHANGE BASED ON ACTUAL FIELD CONDITION.
- 4. THE EXISTING CULVERT TO BE LINED UNDER THIS PROJECT IS STORMWATER FED. THE CONTRACTOR SHALL INSTALL THE PROPOSED CULVERT LINING UNDER WET CONDITIONS AS DESCRIBED IN THE WATER HANDLING NOTES.

SUGGESTED WATER-HANDLING-COFFERDAM DETAIL

NOT TO SCALE

WATER". SEE SPECIAL PROVISIONS.

NOTE: THE COST OF THIS WORK SHALL BE

INCLUDED UNDER THE ITEM "HANDLING

TEMPORARY COFFERDAM -

FLOW LINES

CONSTRUCTION AREA

SCOUR POOL NOT TO SCALE

1 OR 2 TIERS OF INDIVIDUAL

BOULDERS TO BE PLACED AS

FOOTER ROCKS (SEE NOTE 2)

END WALL

18" INTERMEDIATE ROUNDED RIPRAP

MATERIAL PLACED BETWEEN VOIDS

6" GRANULAR FILL —

TOPDRESSED WITH NATURAL STREAMBED


ENVIRONMENTAL PERMIT PLANS - 7/8/19


THOMPSON STATE OF CONNECTICUT BLOCK: 115 GLASTONBURY BLVD SKS 141-154 THE INFORMATION, INCLUDING ESTIMATED GLASTONBURY, CT 06033 QUANTITIES OF WORK, SHOWN ON THESE SHEETS IS BASED ON LIMITED REHABILITATION OF BRIDGE NO. 06793 I-395 OVER LITTLE MOUNTAIN BROOK PB INVESTIGATIONS BY THE STATE AND IS IN NO WAY WARRANTED TO INDICATE **PMT-06** THE CONDITIONS OF ACTUAL QUANTITIES OF WORK WHICH WILL BE REQUIRED. **DEPARTMENT OF TRANSPORTATION** MISCELLANEOUS DETAILS SHEET NO. NOT TO SCALE REVISION DESCRIPTION SHEET NO. Plotted Date: 7/19/2019 Filename: ...\HW_MSH_141_154_MDS1_PERMIT.dgn REV. DATE

ELEVATION - SEE SHEET NO. PMT-05

- BOTTOM OF CHANNEL

FILTER FABRIC

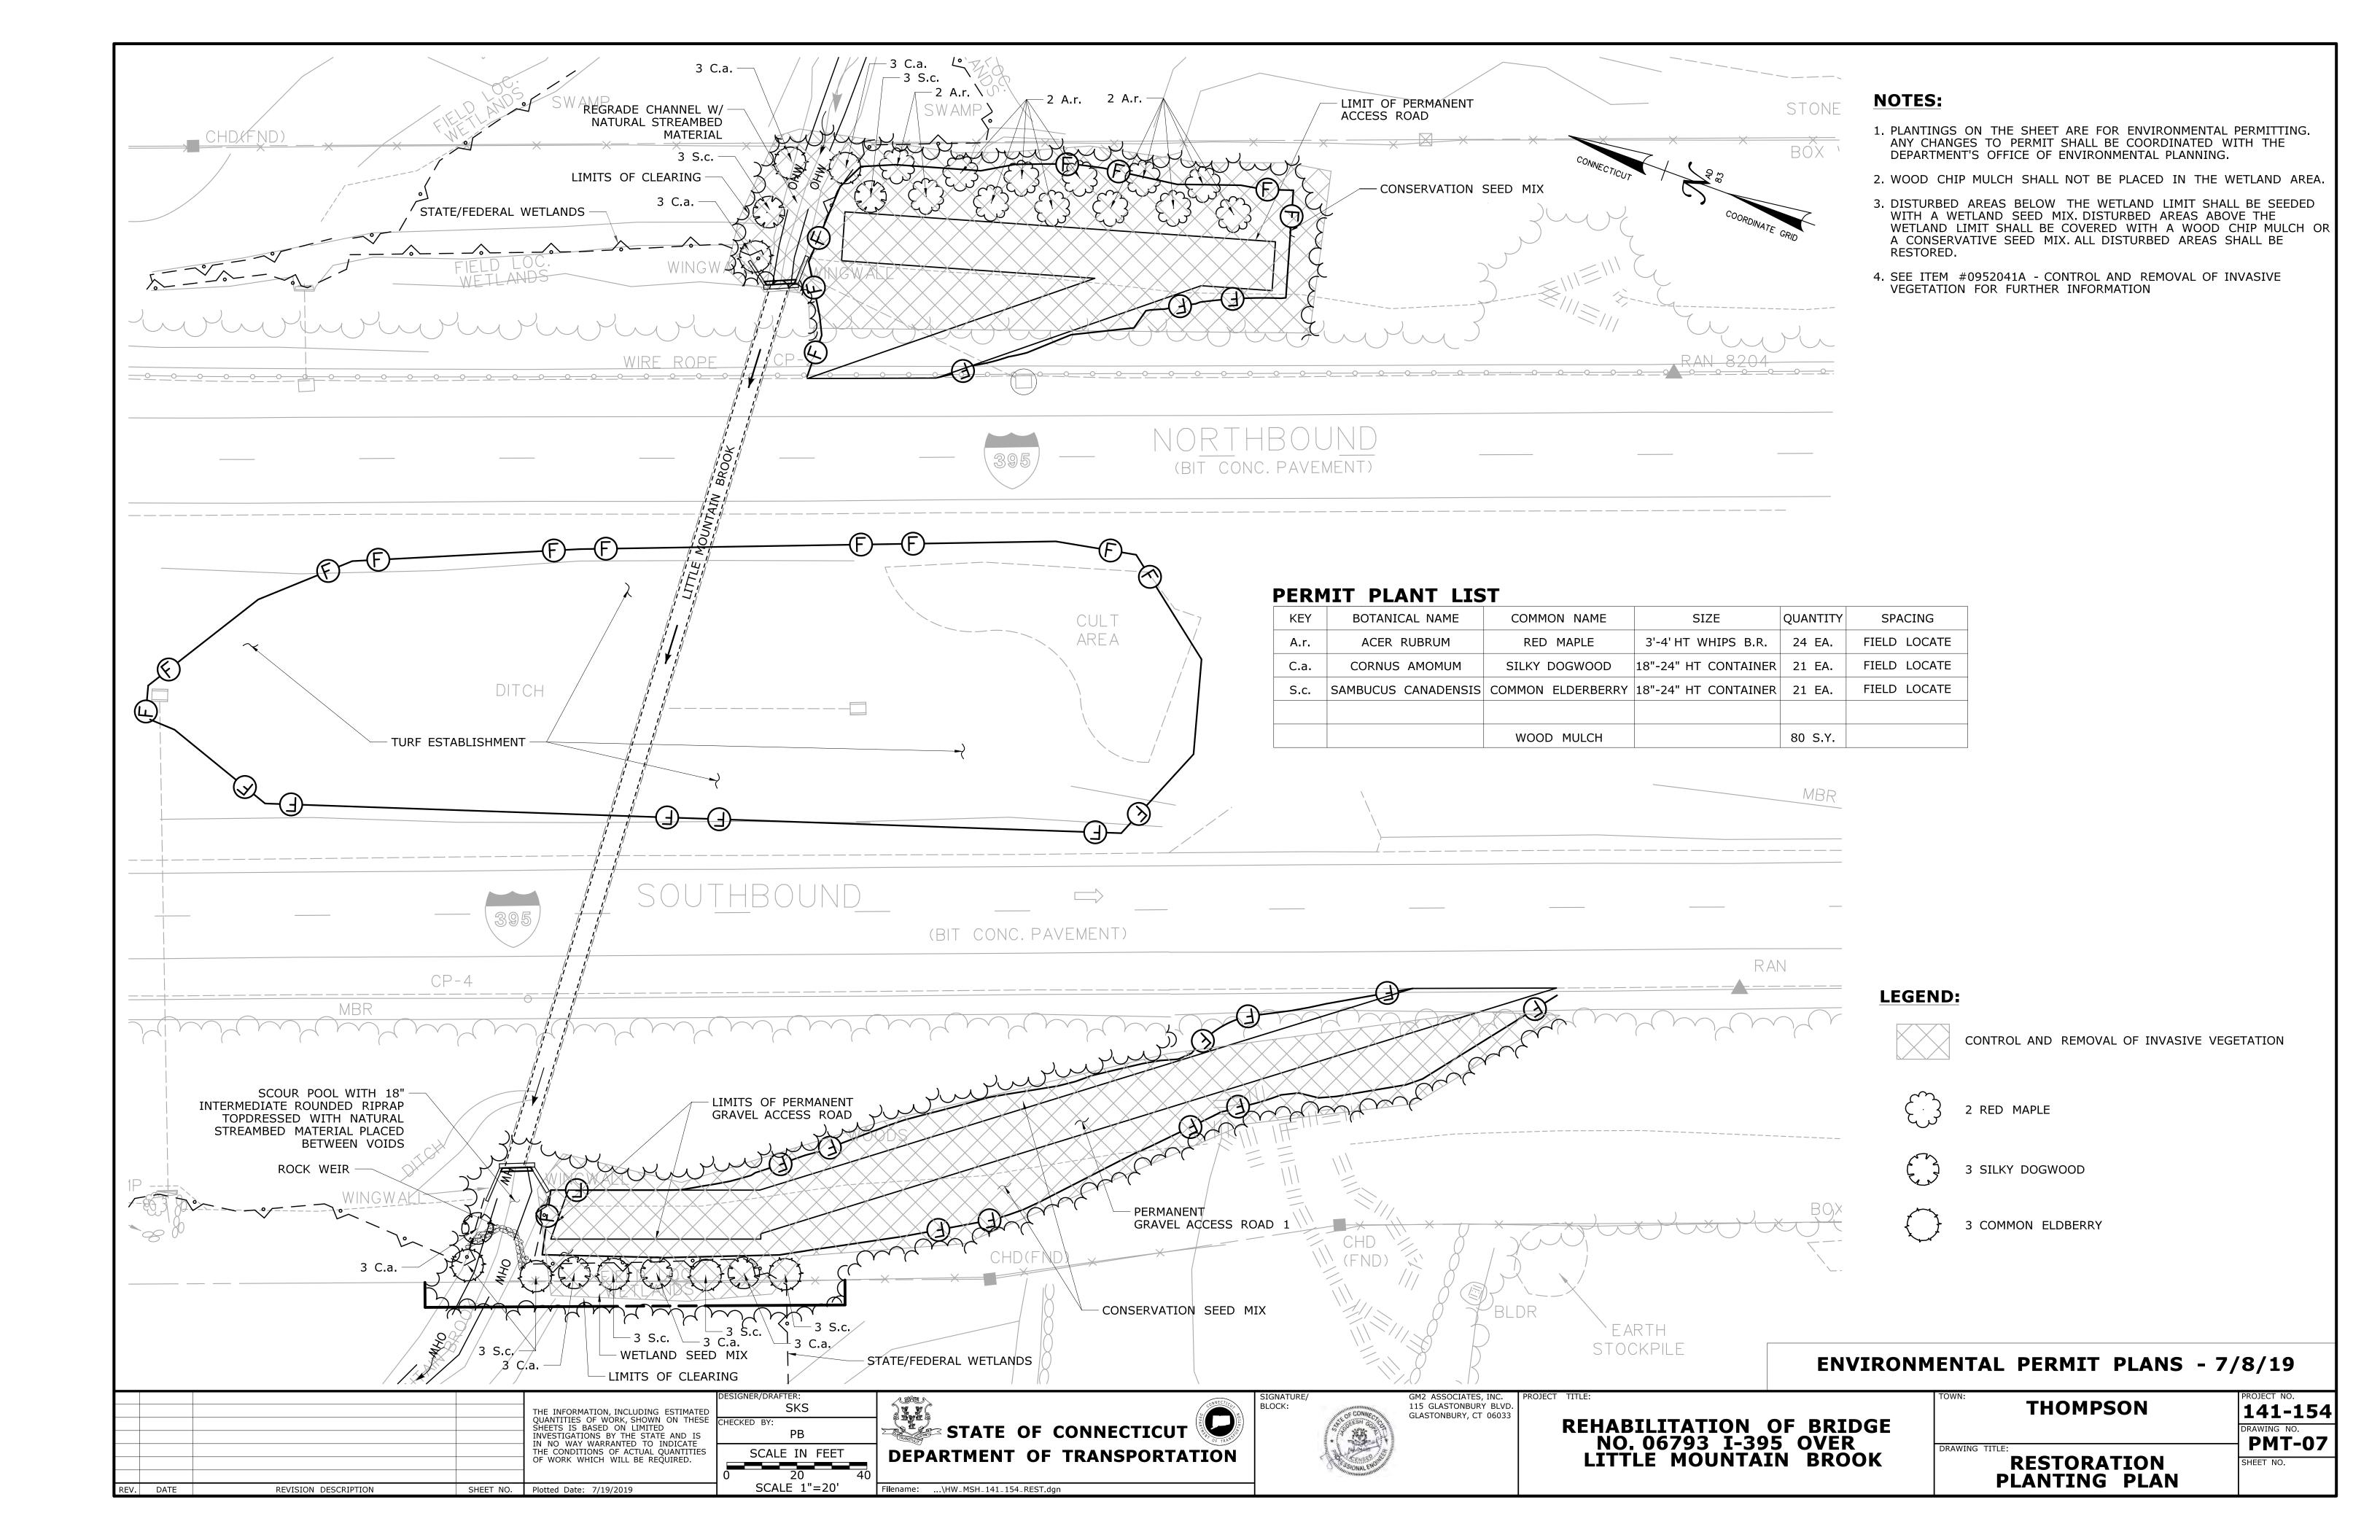


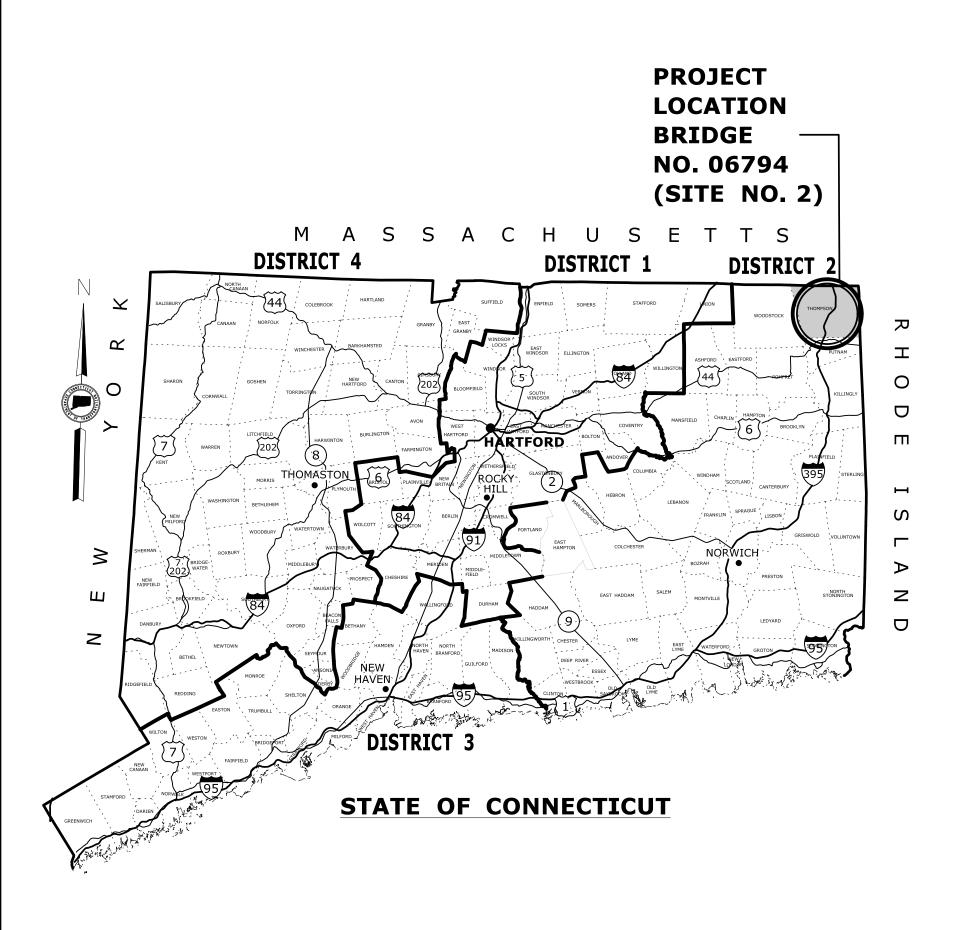

GENERAL NOTES:

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ENVIRONMENTAL PERMIT PLANS STATE PROJECT NO. 141-154 REHABILITATION OF BRIDGE NO. 06794 I-395 OVER UNNAMED BROOK (SITE NO. 2) IN THE TOWN OF THOMPSON

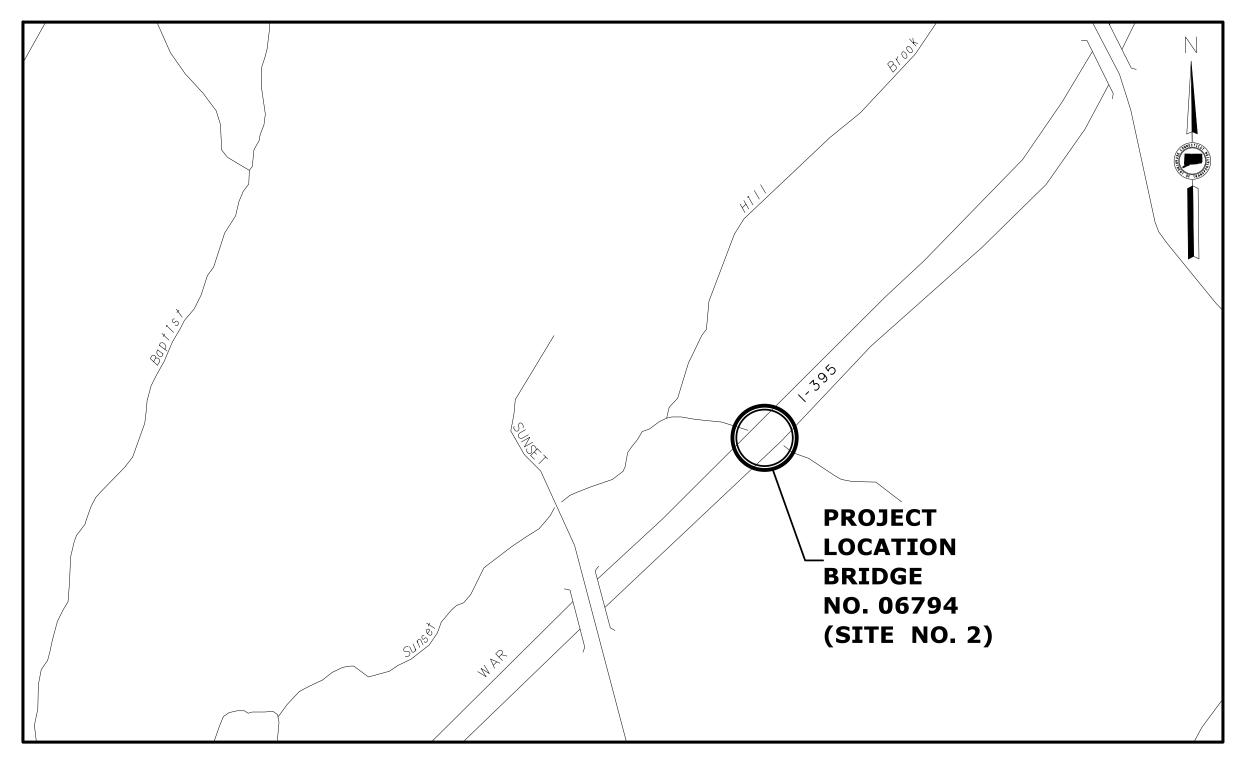

LOCATION PLAN SCALE: 1" = 500'

	LIST OF DRAWINGS
DRAWING NO.	DRAWING TITLE
PMT-01	TITLE SHEET
PMT-02	GENERAL PLAN ACCESS ROAD 1
PMT-03	GENERAL PLAN ACCESS ROAD 2
PMT-04	WETLAND/WATERCOURSE IMPACT PLAN ROAD 1
PMT-05	WETLAND/WATERCOURSE IMPACT PLAN ROAD 2
PMT-06	LONGITUDINAL SECTION AND ELEVATIONS
PMT-07	WATER HANDLING PLAN
PMT-08	MISCELLANEOUS DETAILS
PMT-09	RESTORATION PLANTING PLAN ROAD 1
PMT-10	RESTORATION PLANTING PLAN ROAD 2

DESIGNED BY:
GM2 ASSOCIATES, INC.
115 GLASTONBURY BLVD.
GLASTONBURY, CT 06033

ENVIRONMENTAL PERMIT PLANS - 11/12/19

				Γ
				THE INFORMATION, INCLUDING ESTIMATED OUANTITIES OF WORK, SHOWN ON THESE
				SHEETS IS BASED ON LIMITED
				INVESTIGATIONS BY THE STATE AND IS IN NO WAY WARRANTED TO INDICATE
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				OF WORK WHICH WILL BE REQUIRED.
REV.	DATE	REVISION DESCRIPTION	SHEET NO.	Plotted Date: 11/12/2019


GNER/DRAFTER:
SKS
CKED BY:
JG

SCALE AS NOTED

STATE OF CONNECTICUT DEPARTMENT OF TRANSPORTATION


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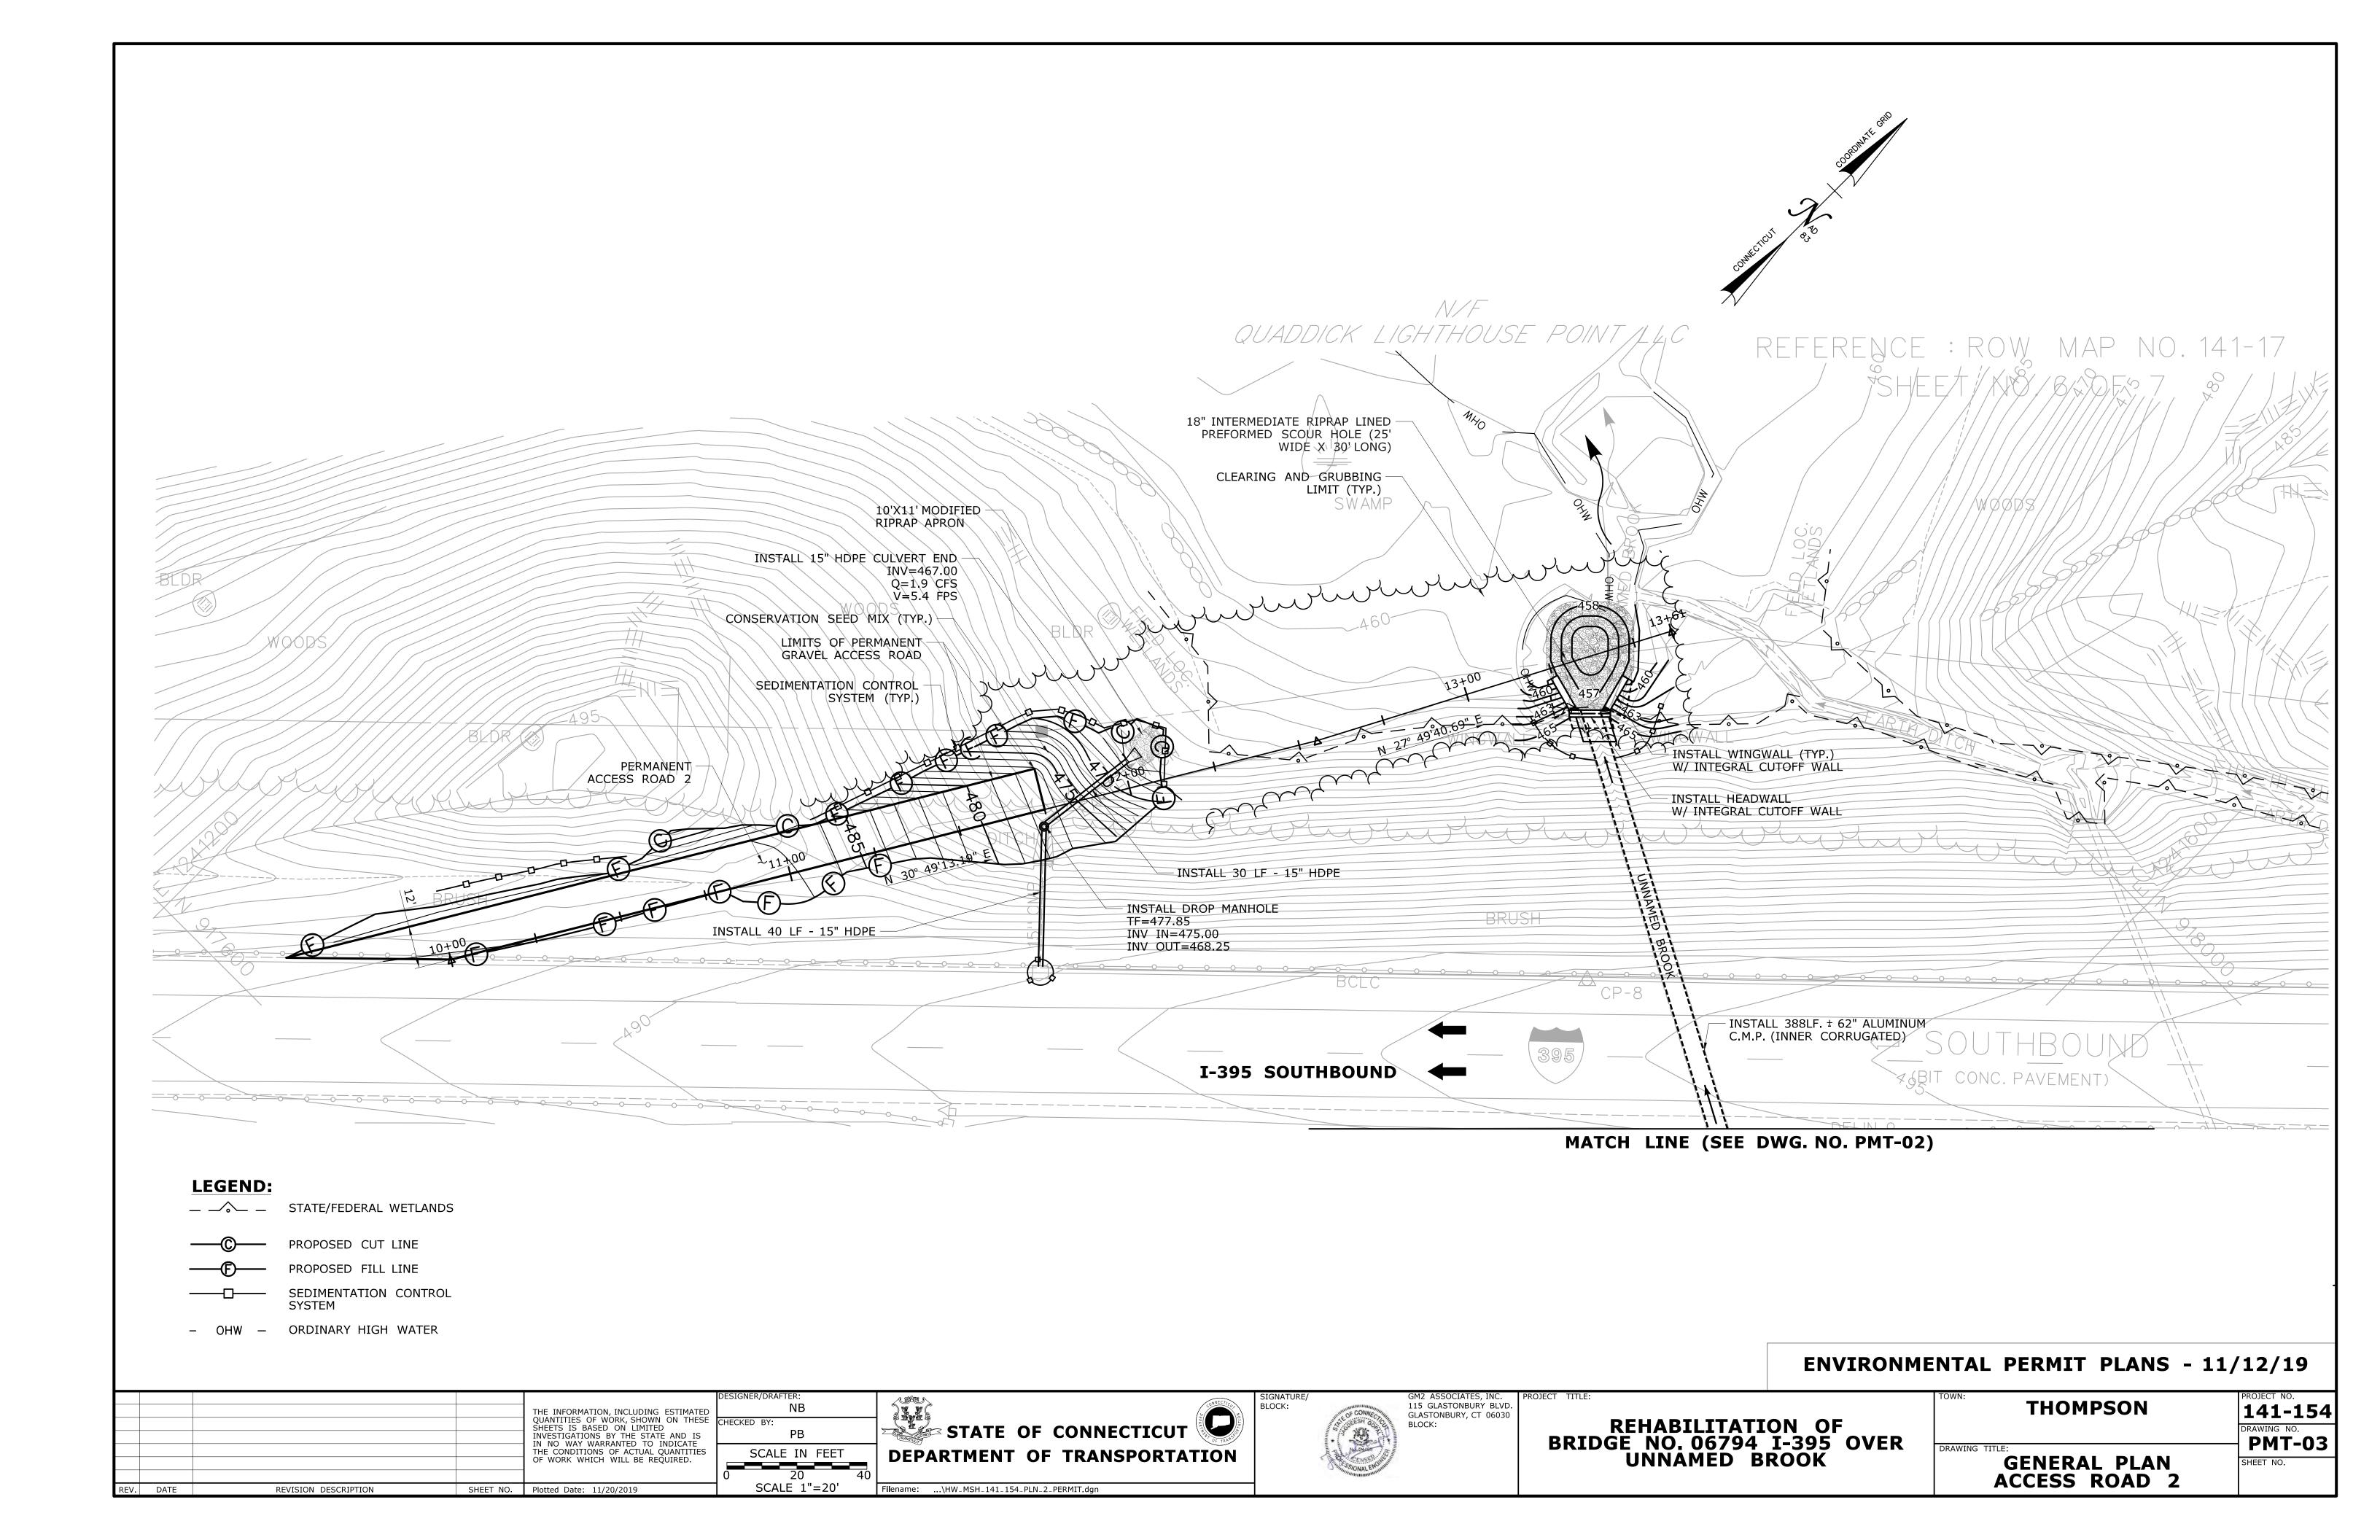


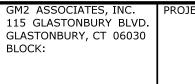



REHABILITATION OF BRIDGE NO. 06794 I-395 OVER UNNAMED BROOK

VN:	PROJECT NO.
THOMPSON	141-154
	DRAWING NO.
AWING TITLE:	PMT-01
TITLE SHEET	SHEET NO.



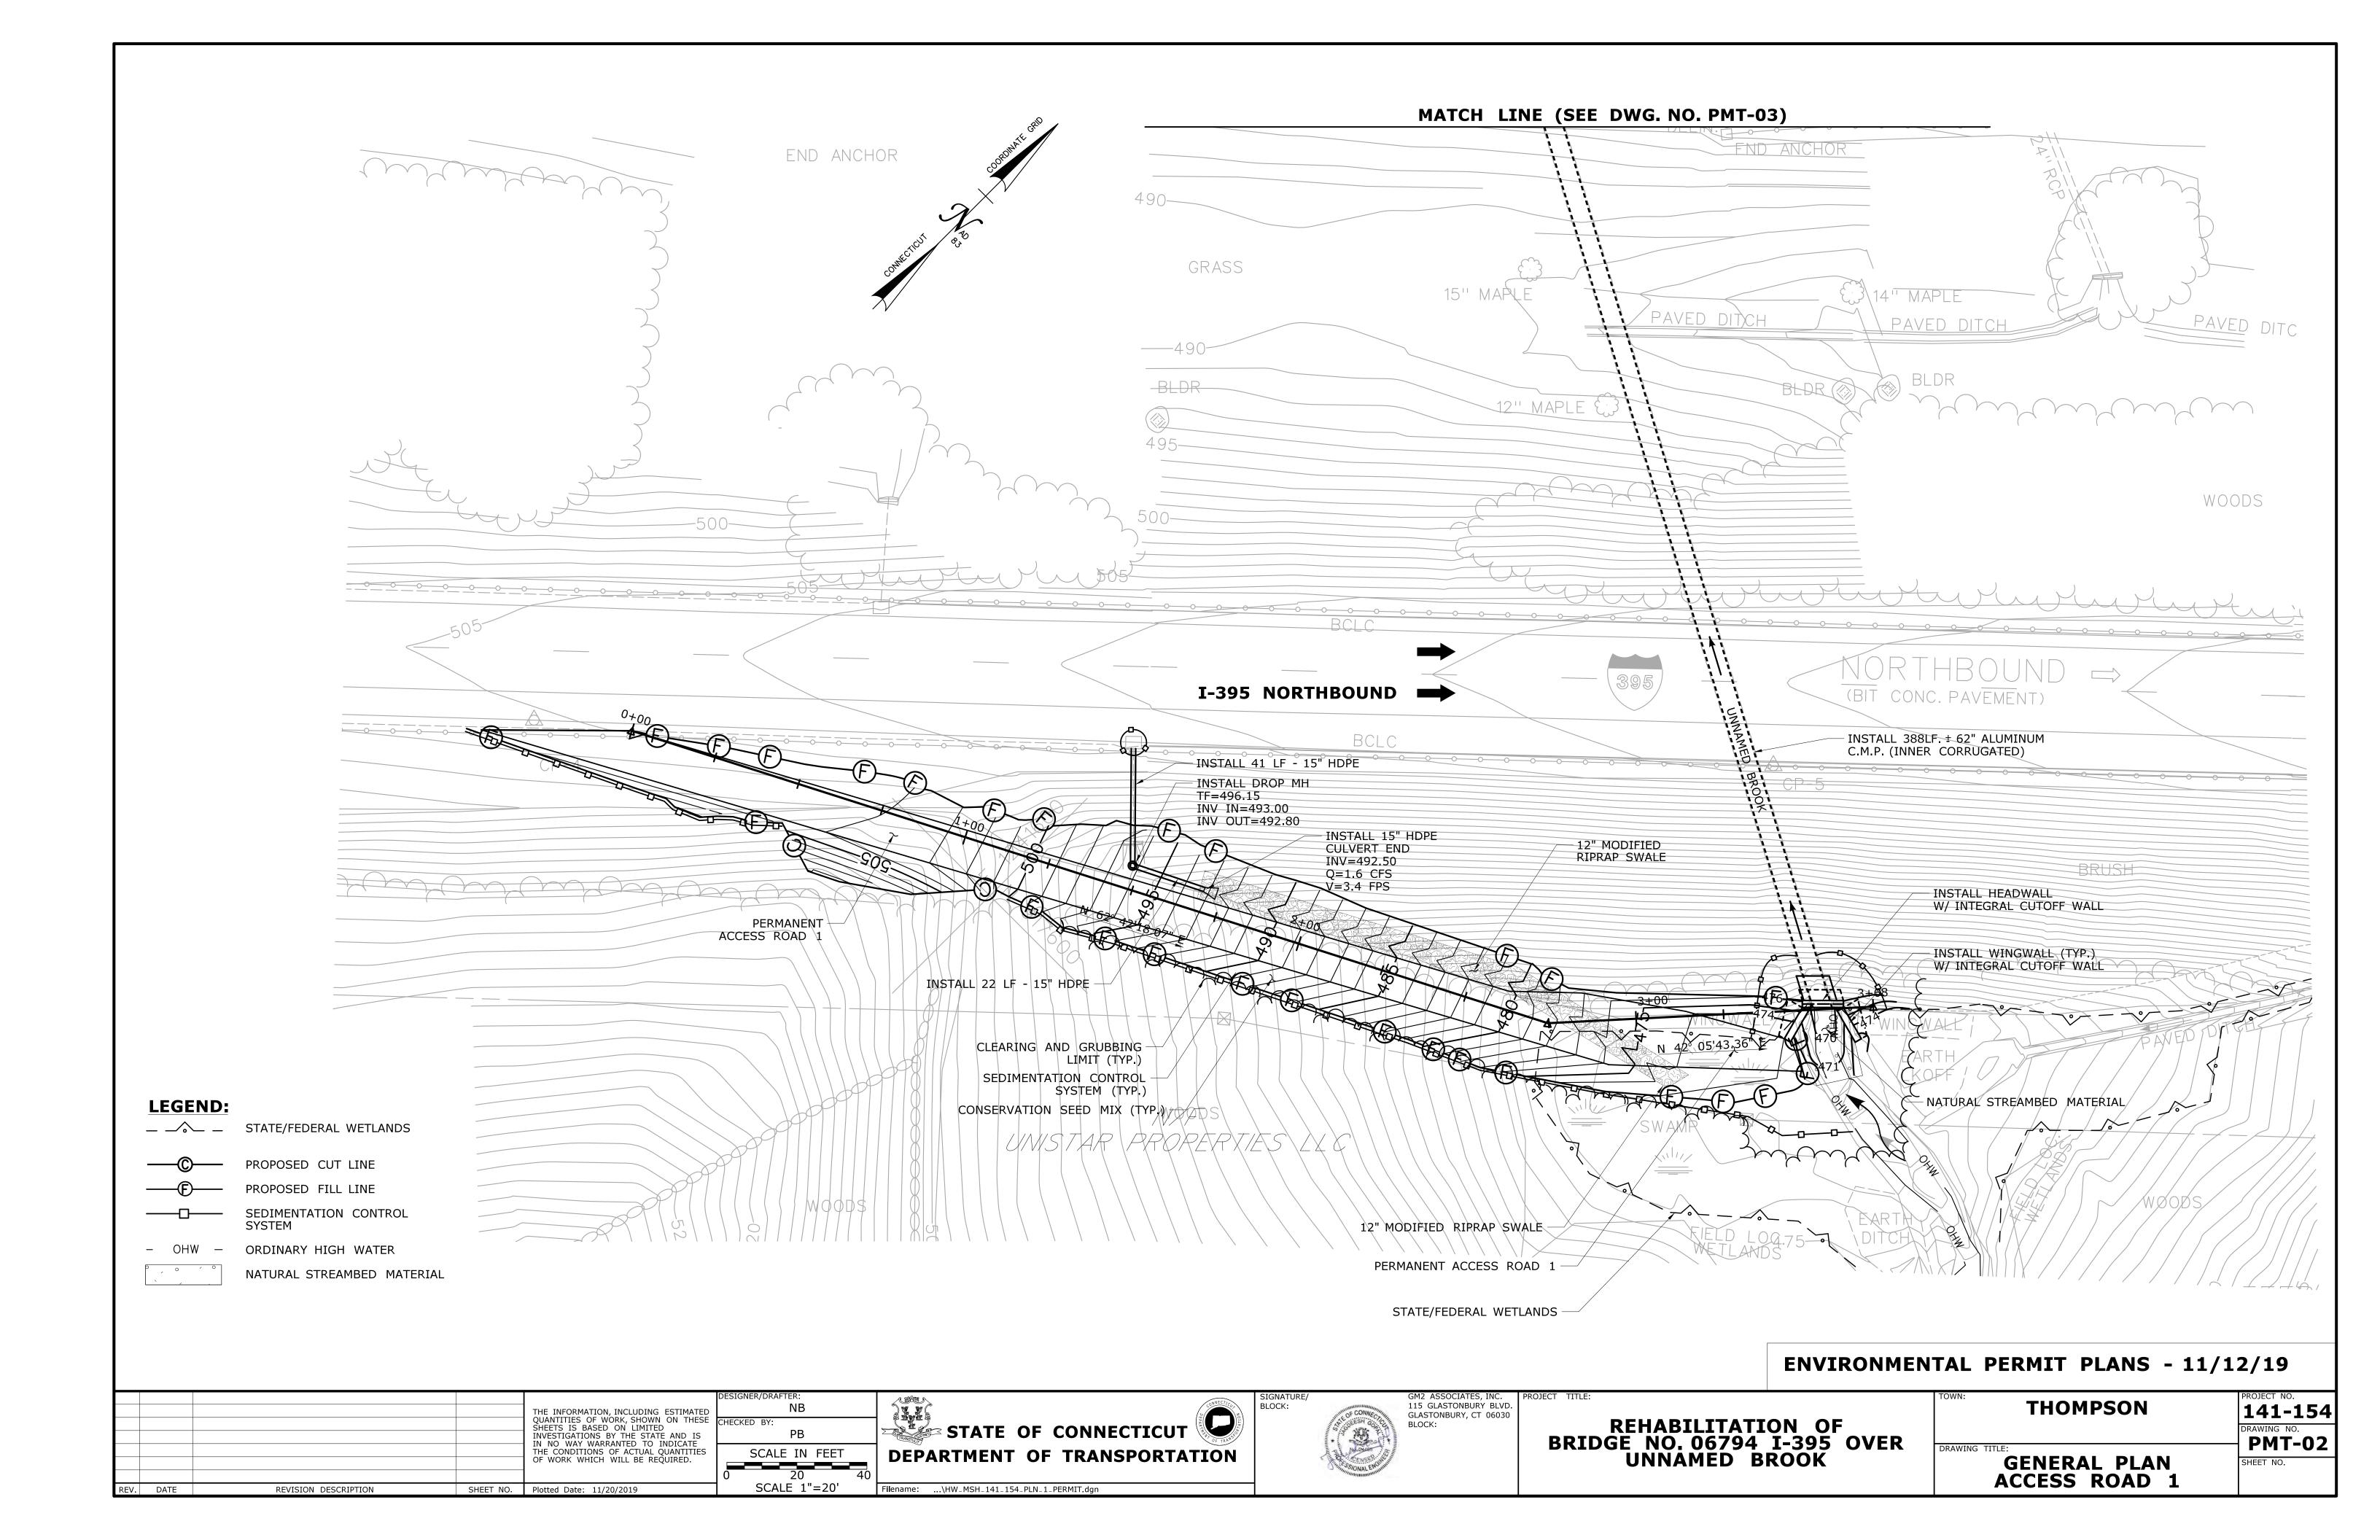

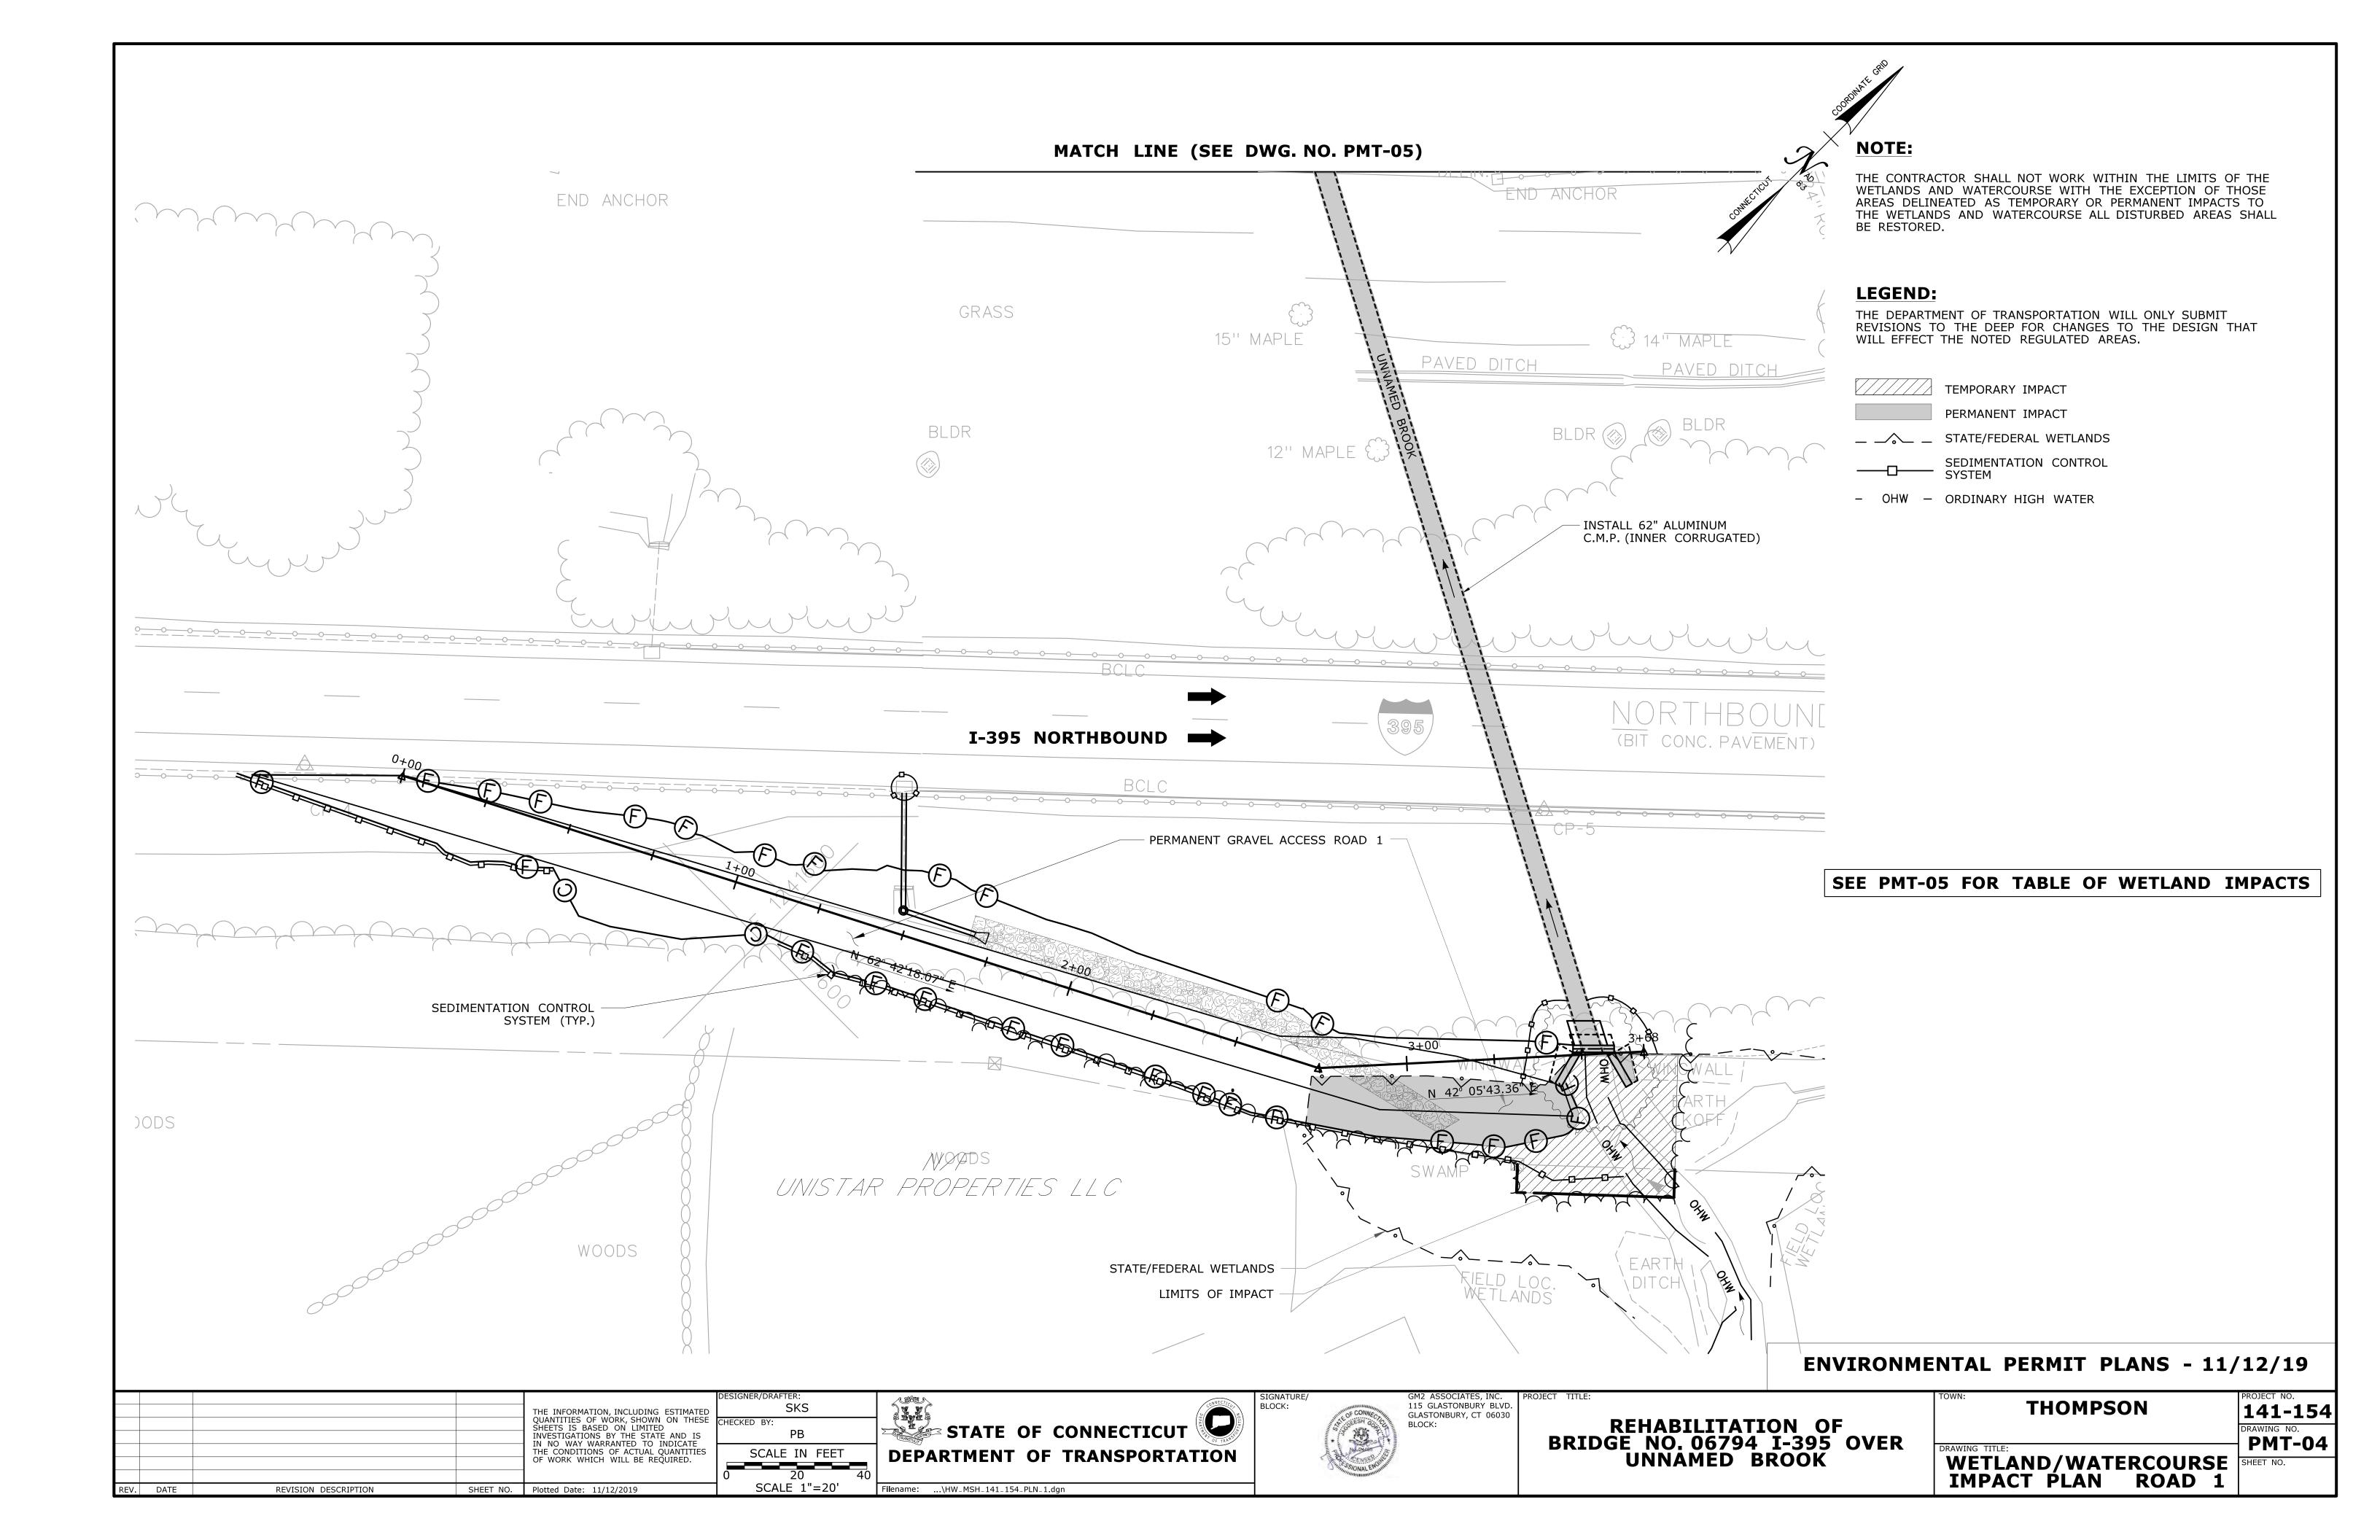

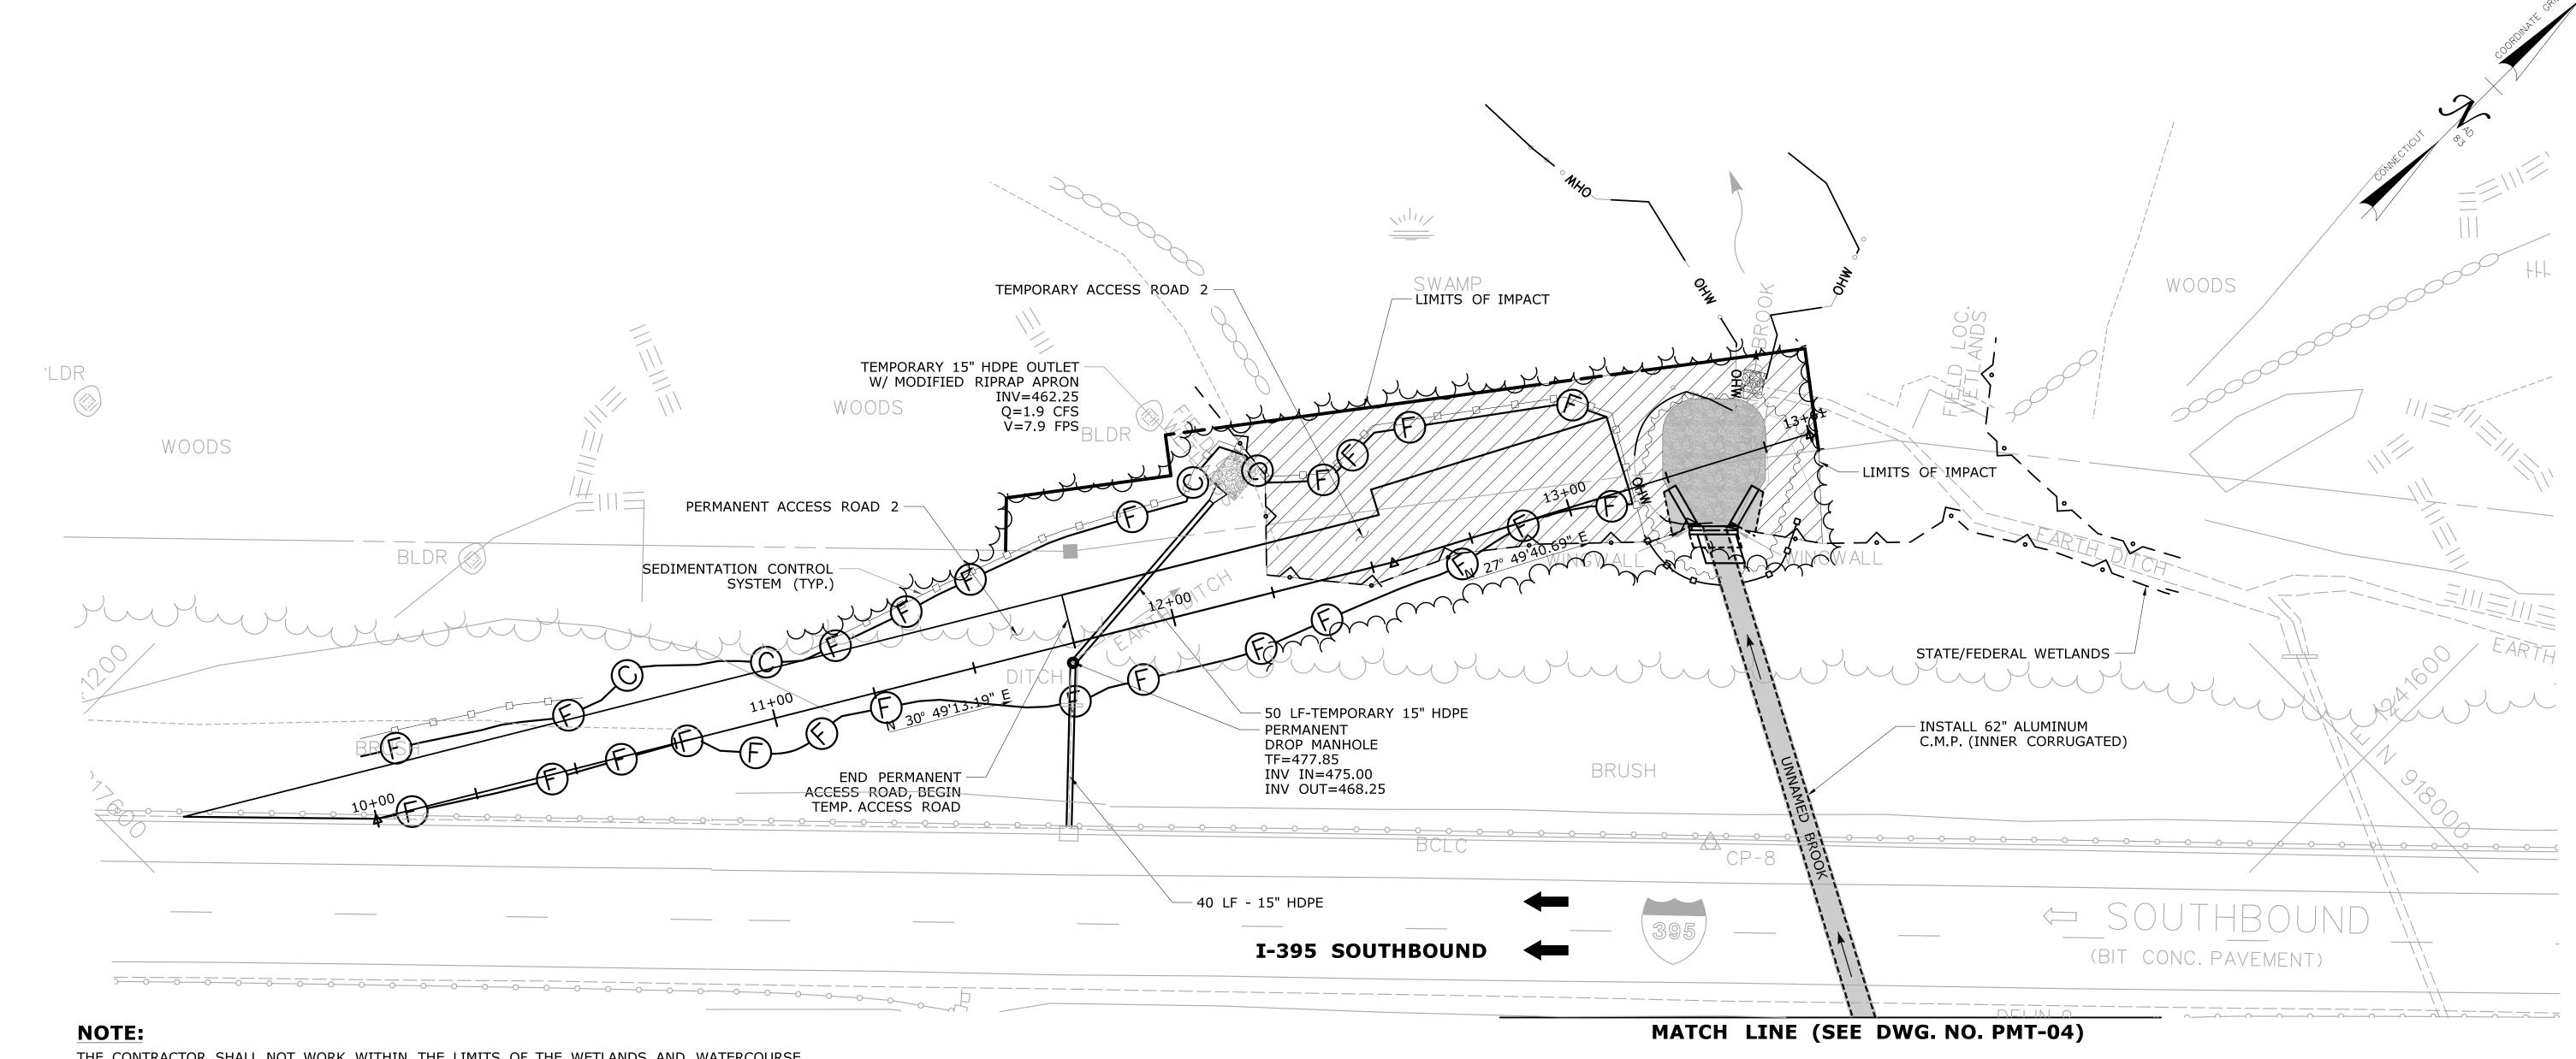


THE CONTRACTOR SHALL NOT WORK WITHIN THE LIMITS OF THE WETLANDS AND WATERCOURSE WITH THE EXCEPTION OF THOSE AREAS DELINEATED AS TEMPORARY OR PERMANENT IMPACTS TO THE WETLANDS AND WATERCOURSE ALL DISTURBED AREAS SHALL BE RESTORED.

WETLAND IMPACT TABLE							
	WETLAND SITE NO.	WETLAND IMPACTS	WATERWAY IMPACTS	TOTAL			
PERMANENT	2	1,617 S.F.	2,978 S.F.	4,595 S.F.			
IMPACTS		(0.037 A.C.)	(0.068 A.C.)	(0.105 A.C.)			
TEMPORARY	2	5,539 S.F.	597 S.F.	6,136 S.F.			
IMPACTS		(0.127 A.C.)	(0.014 A.C.)	(0.141 A.C.)			
TOTAL		7,156 S.F.	3,575 S.F.	10,731 S.F.			
IMPACTS		(0.164 A.C.)	(0.082 A.C.)	(0.246 A.C.)			


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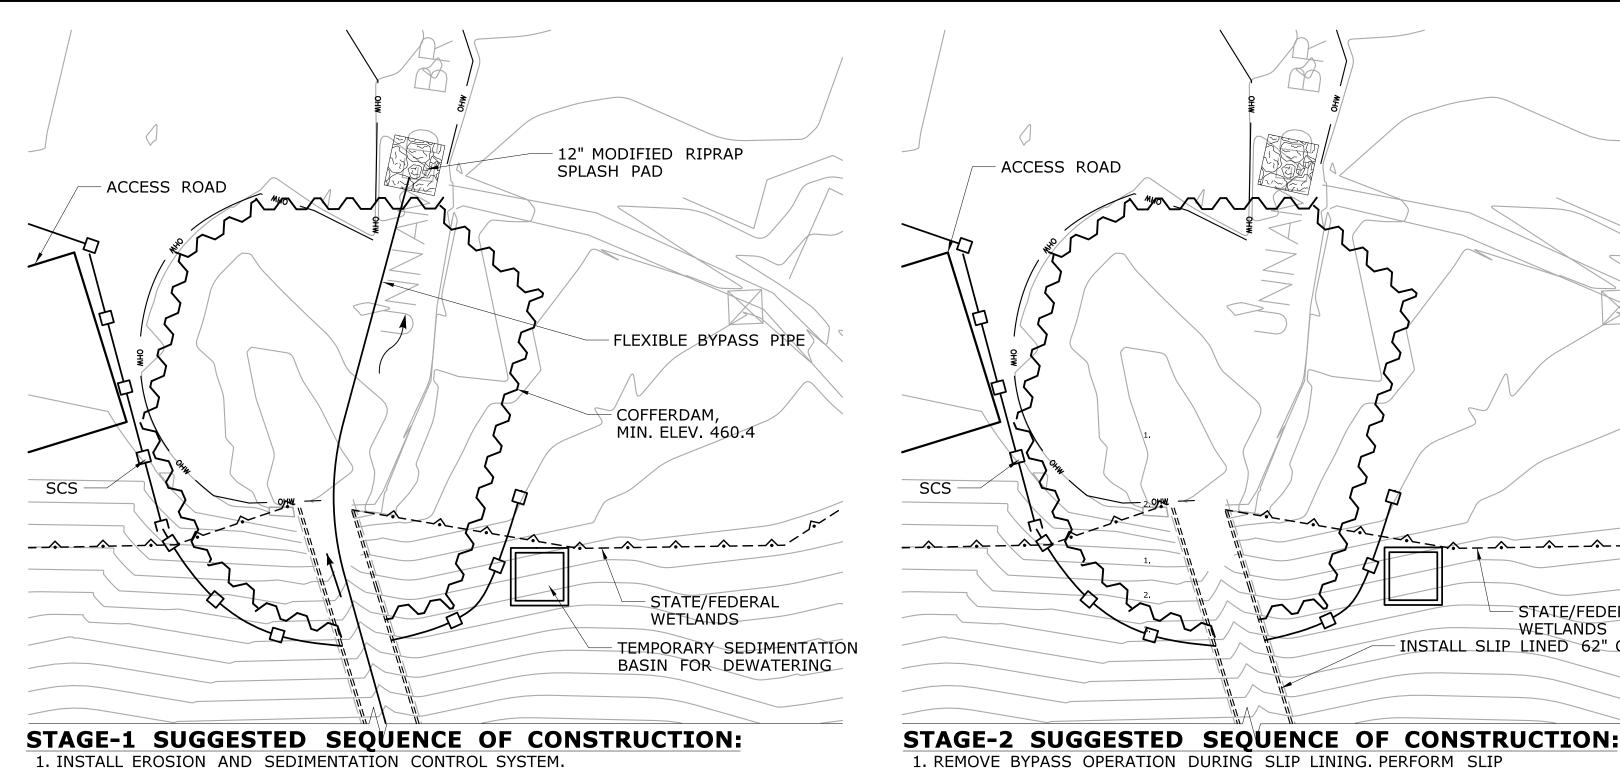
THE DEPARTMENT OF TRANSPORTATION WILL ONLY SUBMIT REVISIONS TO THE DEEP FOR CHANGES TO THE DESIGN THAT WILL EFFECT THE NOTED REGULATED AREAS.

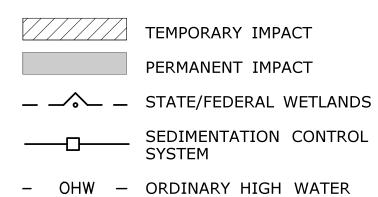

ENVIRONMENTAL PERMIT PLANS - 11/12/19

DESIGNER/DRAFTER: PROJECT NO. GM2 ASSOCIATES, INC. PROJECT TITLE: **THOMPSON** STATE OF CONNECTICUT 115 GLASTONBURY BLVD. SKS 141-154 THE INFORMATION, INCLUDING ESTIMATED GLASTONBURY, CT 06030 QUANTITIES OF WORK, SHOWN ON THESE SHEETS IS BASED ON LIMITED INVESTIGATIONS BY THE STATE AND IS IN NO WAY WARRANTED TO INDICATE THE CONDITIONS OF ACTUAL QUANTITIES OF WORK WHICH WILL BE REQUIRED. REHABILITATION OF BRIDGE NO. 06794 I-395 OVER UNNAMED BROOK DRAWING NO. **PMT-05 DEPARTMENT OF TRANSPORTATION** SCALE IN FEET WETLAND/WATERCOURSE IMPACT PLAN ROAD 2 SCALE 1"=20' REVISION DESCRIPTION Filename: ...\HW_MSH_141_154_PLN_2.dgn SHEET NO. Plotted Date: 11/20/2019 REV. DATE



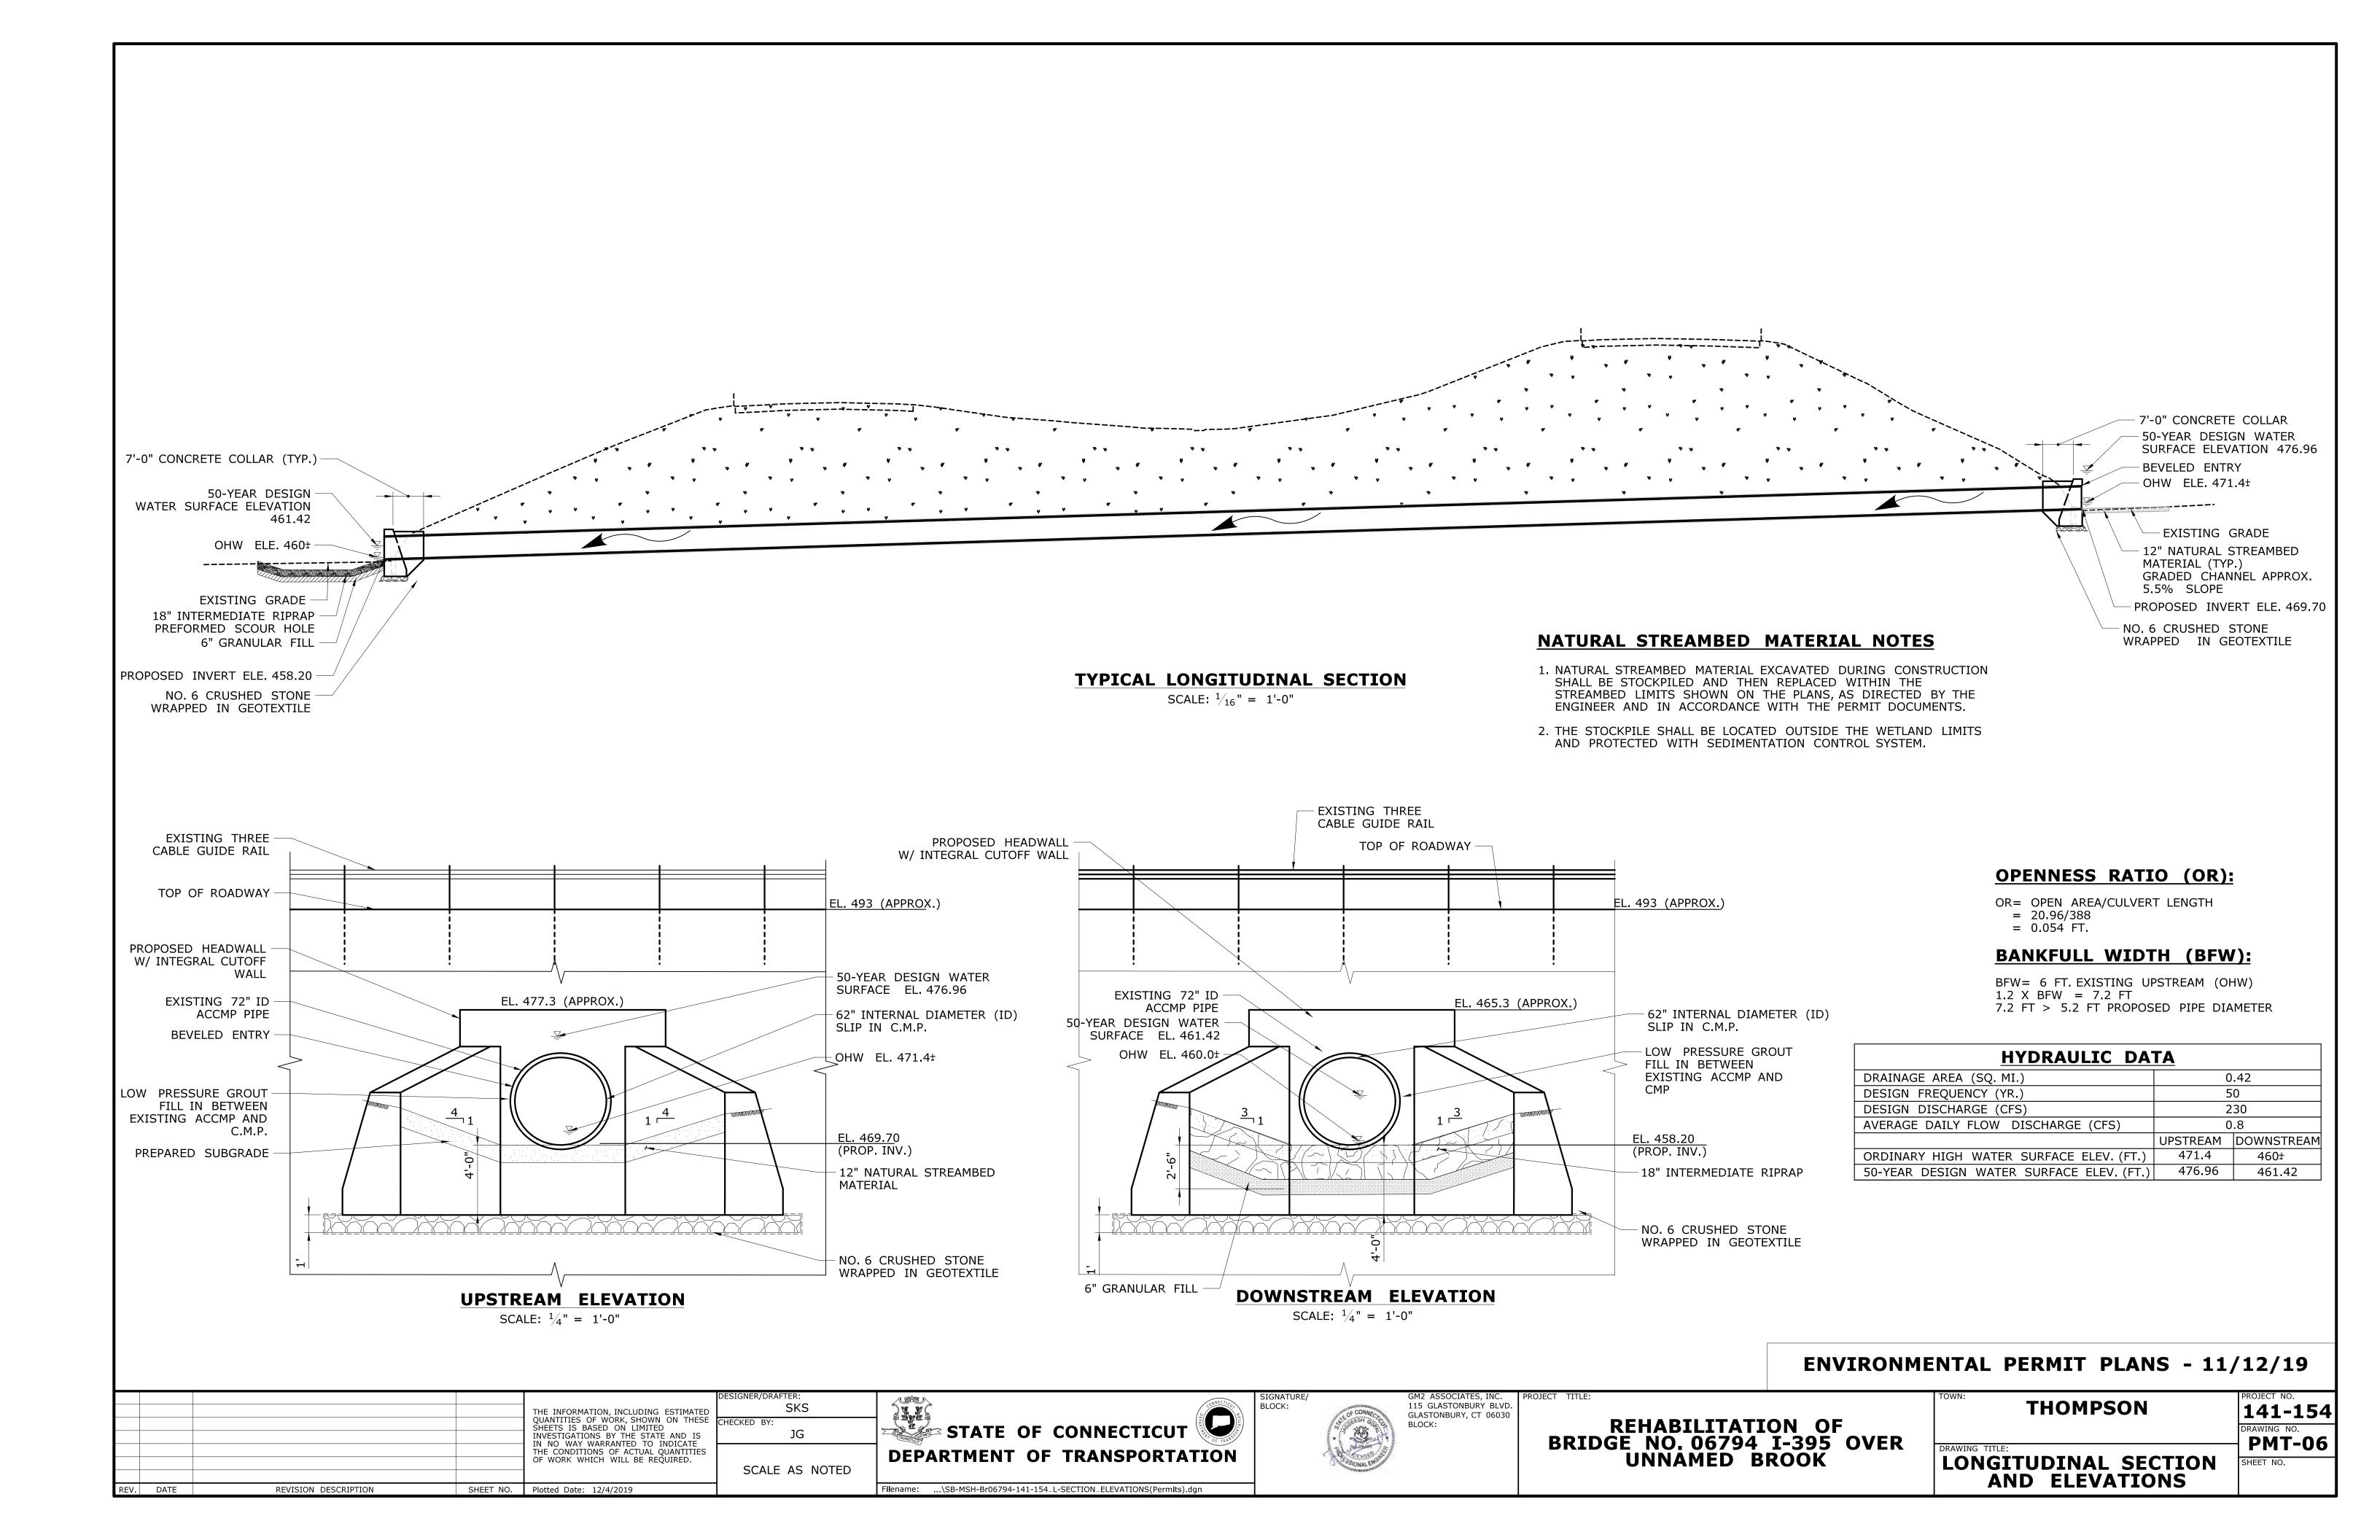


- 1. INSTALL EROSION AND SEDIMENTATION CONTROL SYSTEM.
- 2. PERFORM ALL TRAFFIC CONTROL WORK AND MEDIAN IMPROVEMENT WORK AS SHOWN ON TRAFFIC AND HIGHWAY DRAWINGS.
- 3. INSTALL UPSTREAM AND DOWNSTREAM ACCESS ROADS.
- 4. INSTALL COFFERDAM.

TEMPORARY SEDIMENTATION BASIN FOR

DEWATERING

REV. DATE

- 5. INSTALL STREAM BYPASS PUMPING SYSTEM THROUGH CULVERT.
- 6. CLEAN EXISTING ACCMP PIPE. ALL WORK SHALL BE PERFORMED IN THE DRY.
- 7. PERFORM PRESSURE GROUTING AND REPAIRS OF EXISTING CMP

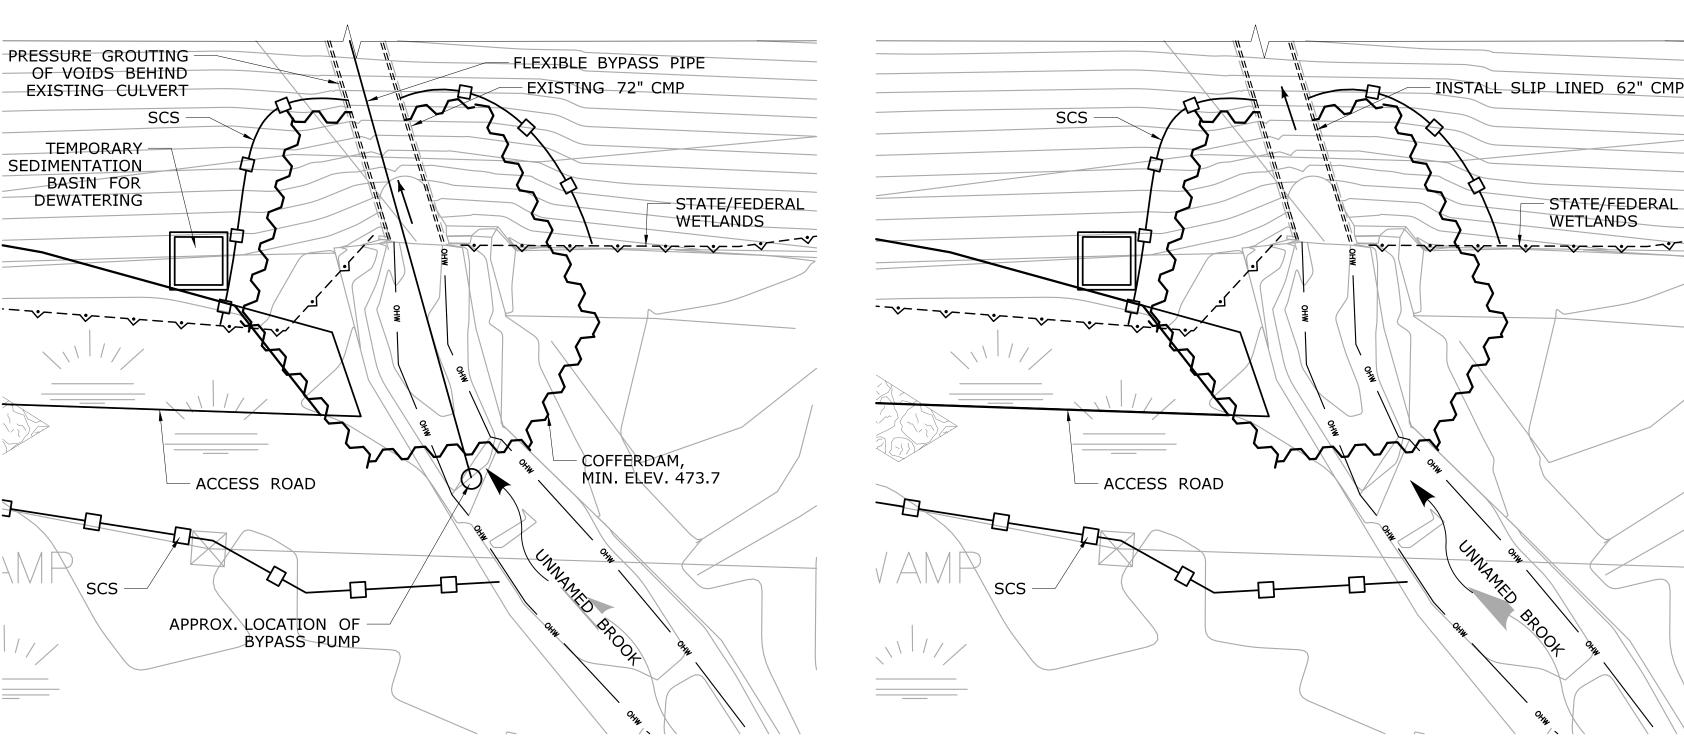

ACCESS ROAD

SCS

LINING IN THE WET.

CONSTRUCTION.

2. INSTALL SPACERS FOR PROPOSED CMP PIPE.

3. INSTALL NEW 62" I.D. CMP SLIP-IN PIPE TO COMPLETE STAGE-2

STAGE-1 WATER HANDLING PLAN

REVISION DESCRIPTION

SCALE: 1'' = 10'THE INFORMATION, INCLUDING ESTIMATED QUANTITIES OF WORK, SHOWN ON THESE SHEETS IS BASED ON LIMITED JG INVESTIGATIONS BY THE STATE AND IS IN NO WAY WARRANTED TO INDICATE THE CONDITIONS OF ACTUAL QUANTITIES OF WORK WHICH WILL BE REQUIRED.

SHEET NO. Plotted Date: 11/20/2019

SKS SCALE AS NOTED


STATE OF CONNECTICUT **DEPARTMENT OF TRANSPORTATION**


Filename: ...\SB-MSH-Br06794-141-154_WH PLAN.dan


STAGE-2 WATER HANDLING PLAN

SCALE: 1'' = 10'



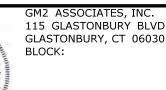

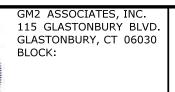

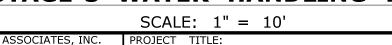

ACCESS ROAD

ENVIRONMENTAL PERMIT PLANS - 11/12/19

REHABILITATION OF BRIDGE NO. 06794 I-395 OVER UNNAMED BROOK

WATER HANDLING **PLAN**

PMT-07

THOMPSON 141-154

STAGE-3 SUGGESTED SEQUENCE OF CONSTRUCTION: 1. REINSTALL BYPASS OPERATING DURING GROUTING OF ANNULAR SPACE PUMPING SYSTEM (SHOWN) OR 15" MIN. DIA. GRAVITY PIPE ACCEPTABLE.

- 2. INSTALL HEADWALLS AND WINGWALLS W/ INTEGRAL CUTOFF WALL.
- 3. PERFORM GROUTING OF ANNULAR SPACE IN LIFTS PER SPECIFICATIONS.
- 3. PREPARE SUBGRADE OF INLET AND OUTLET AREAS.

SLIP LINING GROUT (TYP.)

ACCESS ROAD

- 4. INSTALL NATURAL STREAMBED MATERIAL AT INLET AND 18" INTERMEDIATE RIPRAP PREFORMED SCOUR HOLE AT OUTLET.
- 5. REMOVE COFFERDAMS.


SCS

STATE/FEDERAL

WETLANDS

INSTALL SLIP LINED 62" CMP

- 6. REMOVE BYPASS OPERATION AND OPEN NEW CULVERT TO STREAM FLOWS.
- 7. RESTORE DISTURBED AREAS AND INSTALL PLANTINGS AS DEPICTED ON PMT-09 AND PMT-10.
- 8. REMOVE E&S CONTROL SYSTEM UPON PERMANENT STABILIZATION.

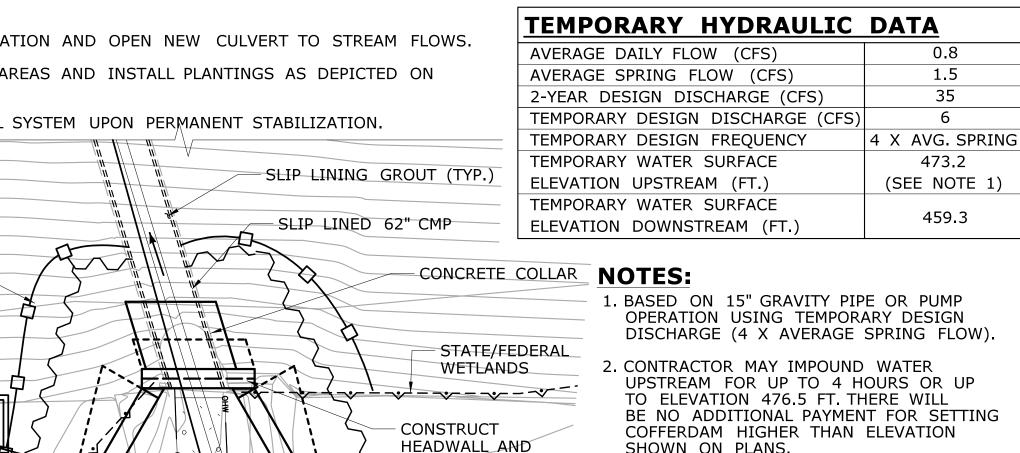

WINGWALLS W/ INTEGRAL CUTOFF

REGRADE CHANNEL

STREAMBED MATERIAL

WITH NATURAL

WALL

OPTIONAL 15"

GRAVITY PIPE

PREFORMED SCOUR

HOLE W/ 18" INTERMEDIATE

RIPRAP LINING

 FLEXIBLE BYPASS PIPE

HEADWALL AND

WINGWALLS W/ INTEGRAL CUTOFF

CONSTRUCT

WALL

STATE/FEDERAL

WETLANDS

LEGEND:

~~~~~

- OHW -

STRUCTURE.

ENGINEER.

ENGINEER.

STATE/FEDERAL WETLANDS

TEMPORARY COFFERDAMS

SEDIMENTATION CONTROL

ORDINARY HIGH WATER

RIPRAP

WATER HANDLING NOTES:

A PUMP DISCHARGE BASIN SHALL BE

SUBMISSION AND APPROVED BY THE

OCCUR AT THE UPSTREAM SIDE FOR

ESTABLISHED OUTSIDE OF THE WETLAND LIMITS. THE LOCATION OF THE DEWATERING

1. THE CONTRACTOR SHALL MAINTAIN WATER

THROUGH THE TEMPORARY BYPASS PIPE AS SHOWN DURING CONSTRUCTION OF NEW

. EQUIPMENT SHALL NOT BE PERMITTED IN THE

NOT IN PLACE WITHOUT APPROVAL FROM THE

BASIN IS APPROXIMATE. THE EXACT POSITION

MAY VARY BASED ON THE PUMPING DESIGN

4. THE CONTRACTOR MAY ALLOW PONDING TO

INTERVALS OF FOUR HOURS WITHOUT PUMPING


DURING OPERATIONS, PER CTDEEP FISHERIES.


STREAM WHEN TEMPORARY BYPASS PIPE IS


NATURAL STREAMBED MATERIAL

- COFFERDAM HIGHER THAN ELEVATION SHOWN ON PLANS.
- 3. STORAGE TIME WILL BE REDUCED TO LESS THAN 4 HOURS WHEN FLOWS EXCEED THE AVERAGE SPRING FLOW.
- 4. ADDITIONAL COFFERDAMMING NEEDED TO KEEP STAGING AREA DRY DURING 4 HOUR IMPOUNDMENT SHALL BE WITHIN PERMITTED IMPACT AREAS AND COME AT NO ADDITIONAL COST TO THE STATE.

STAGE-3 WATER HANDLING PLAN

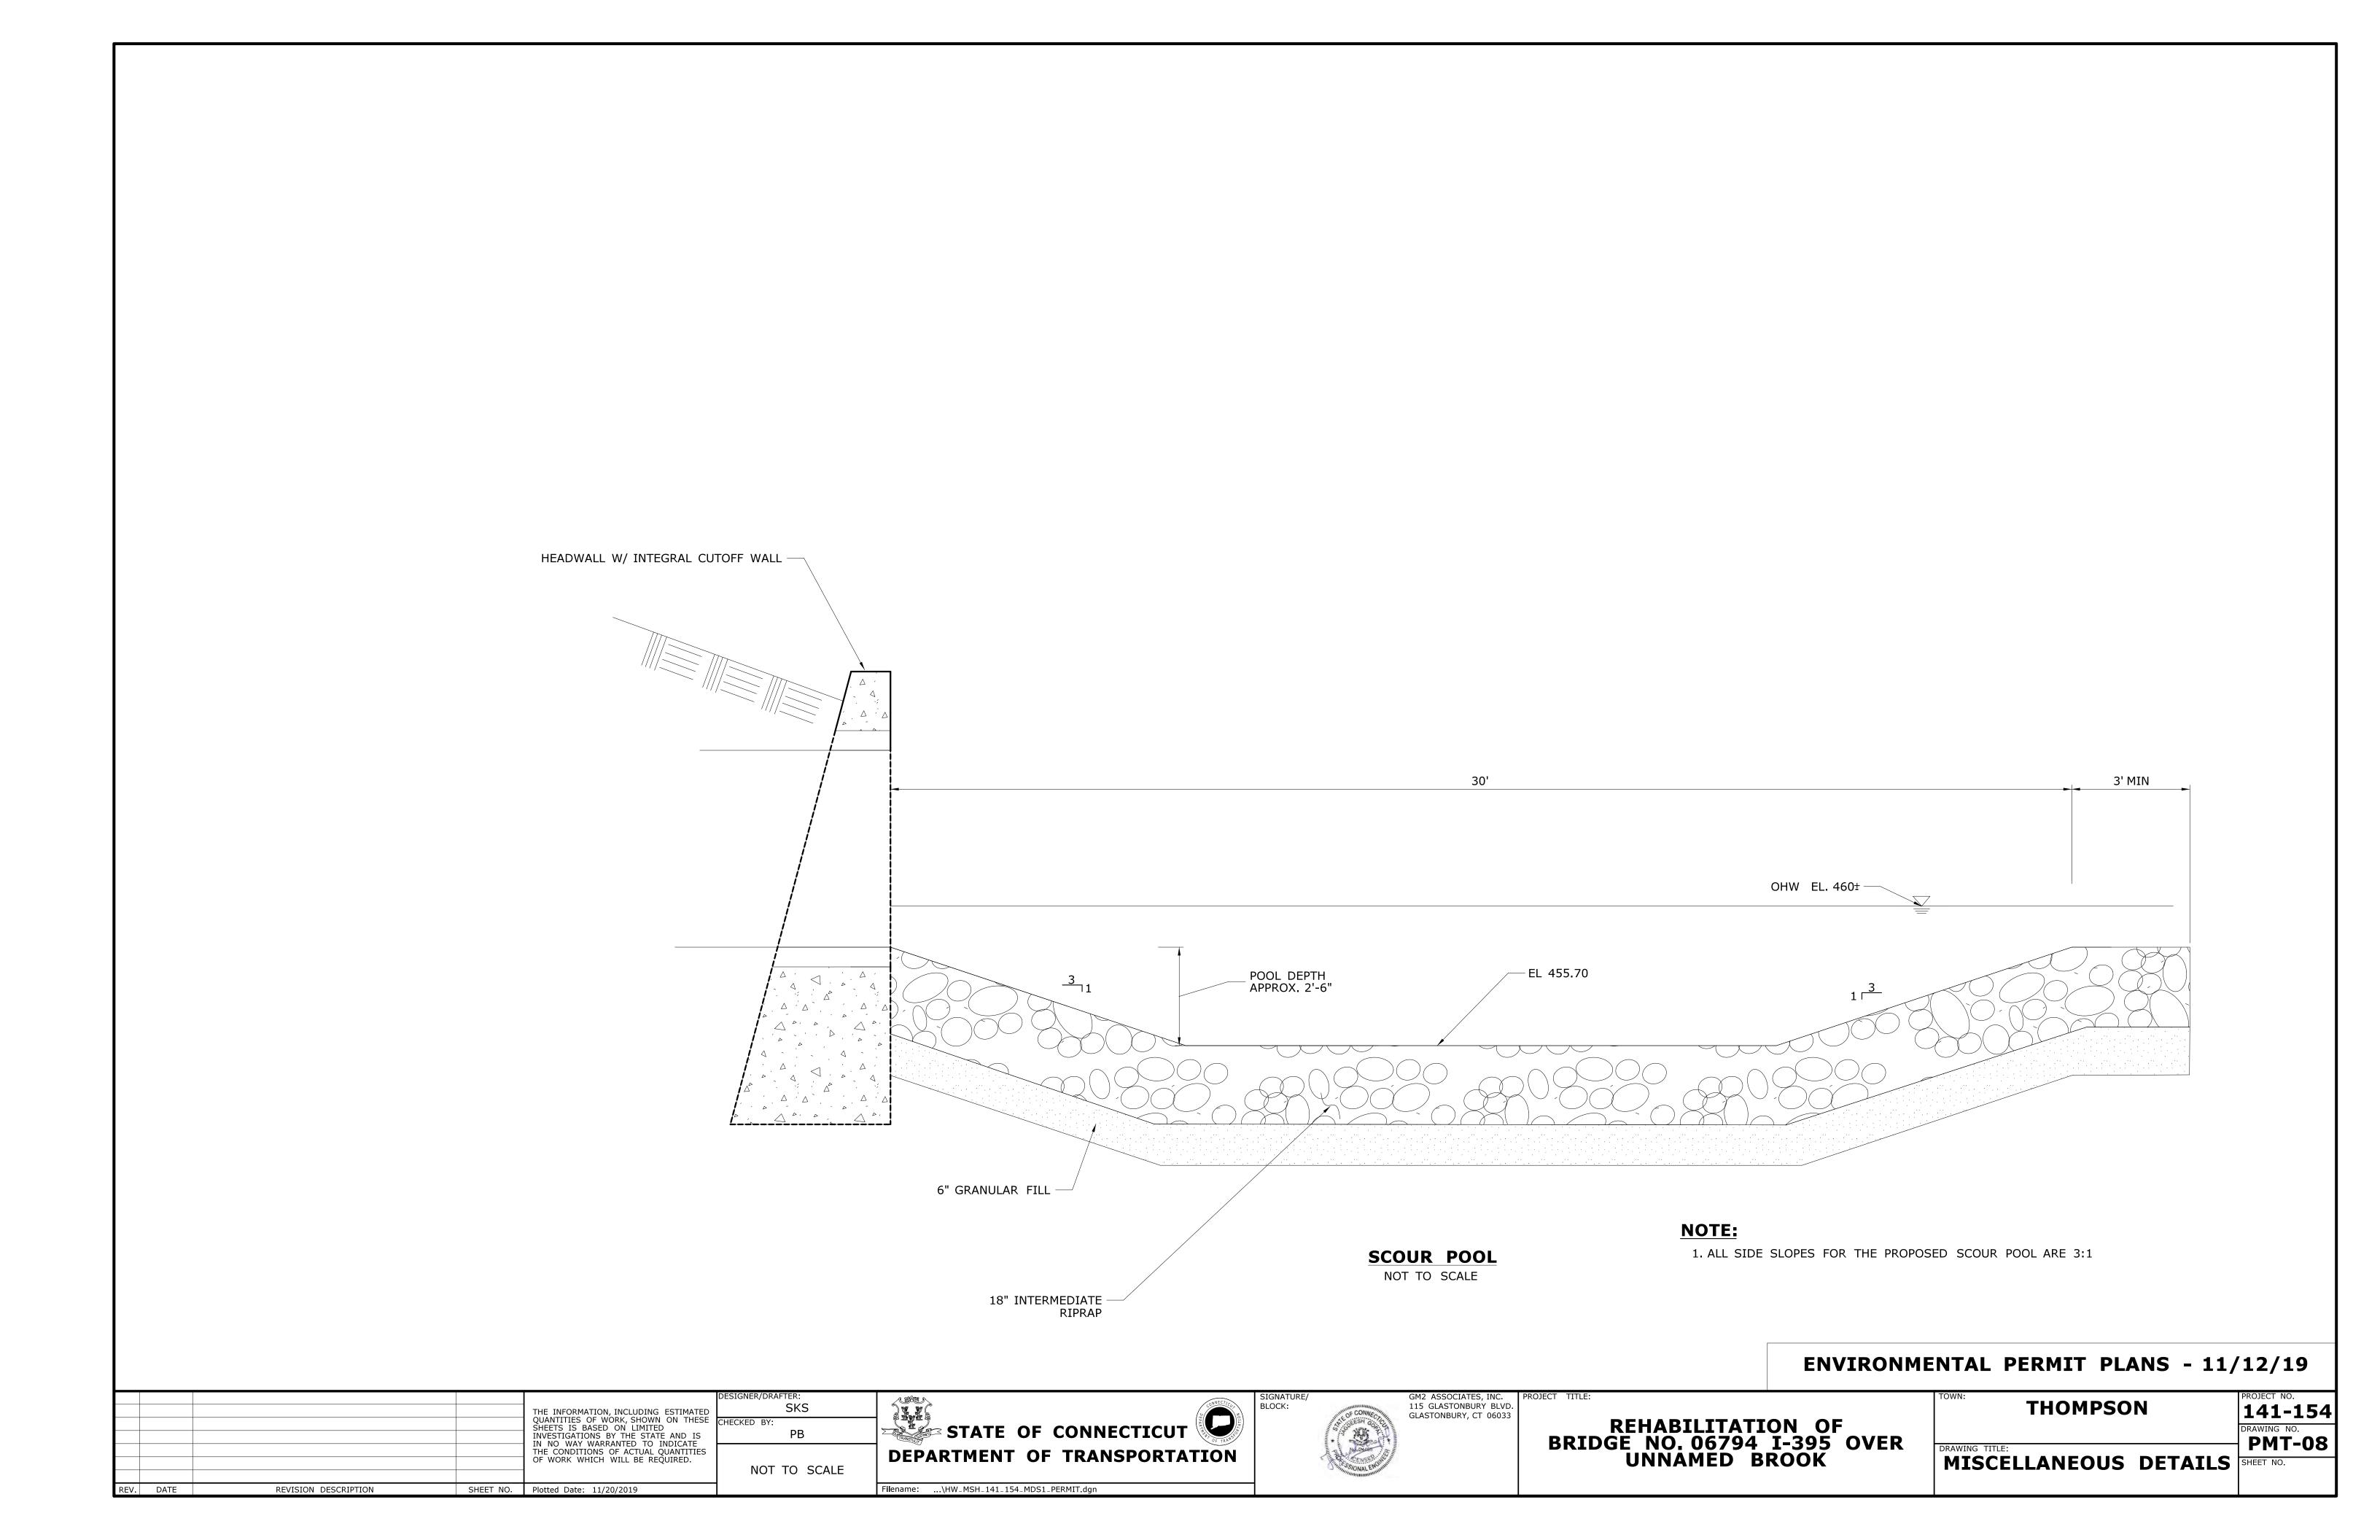

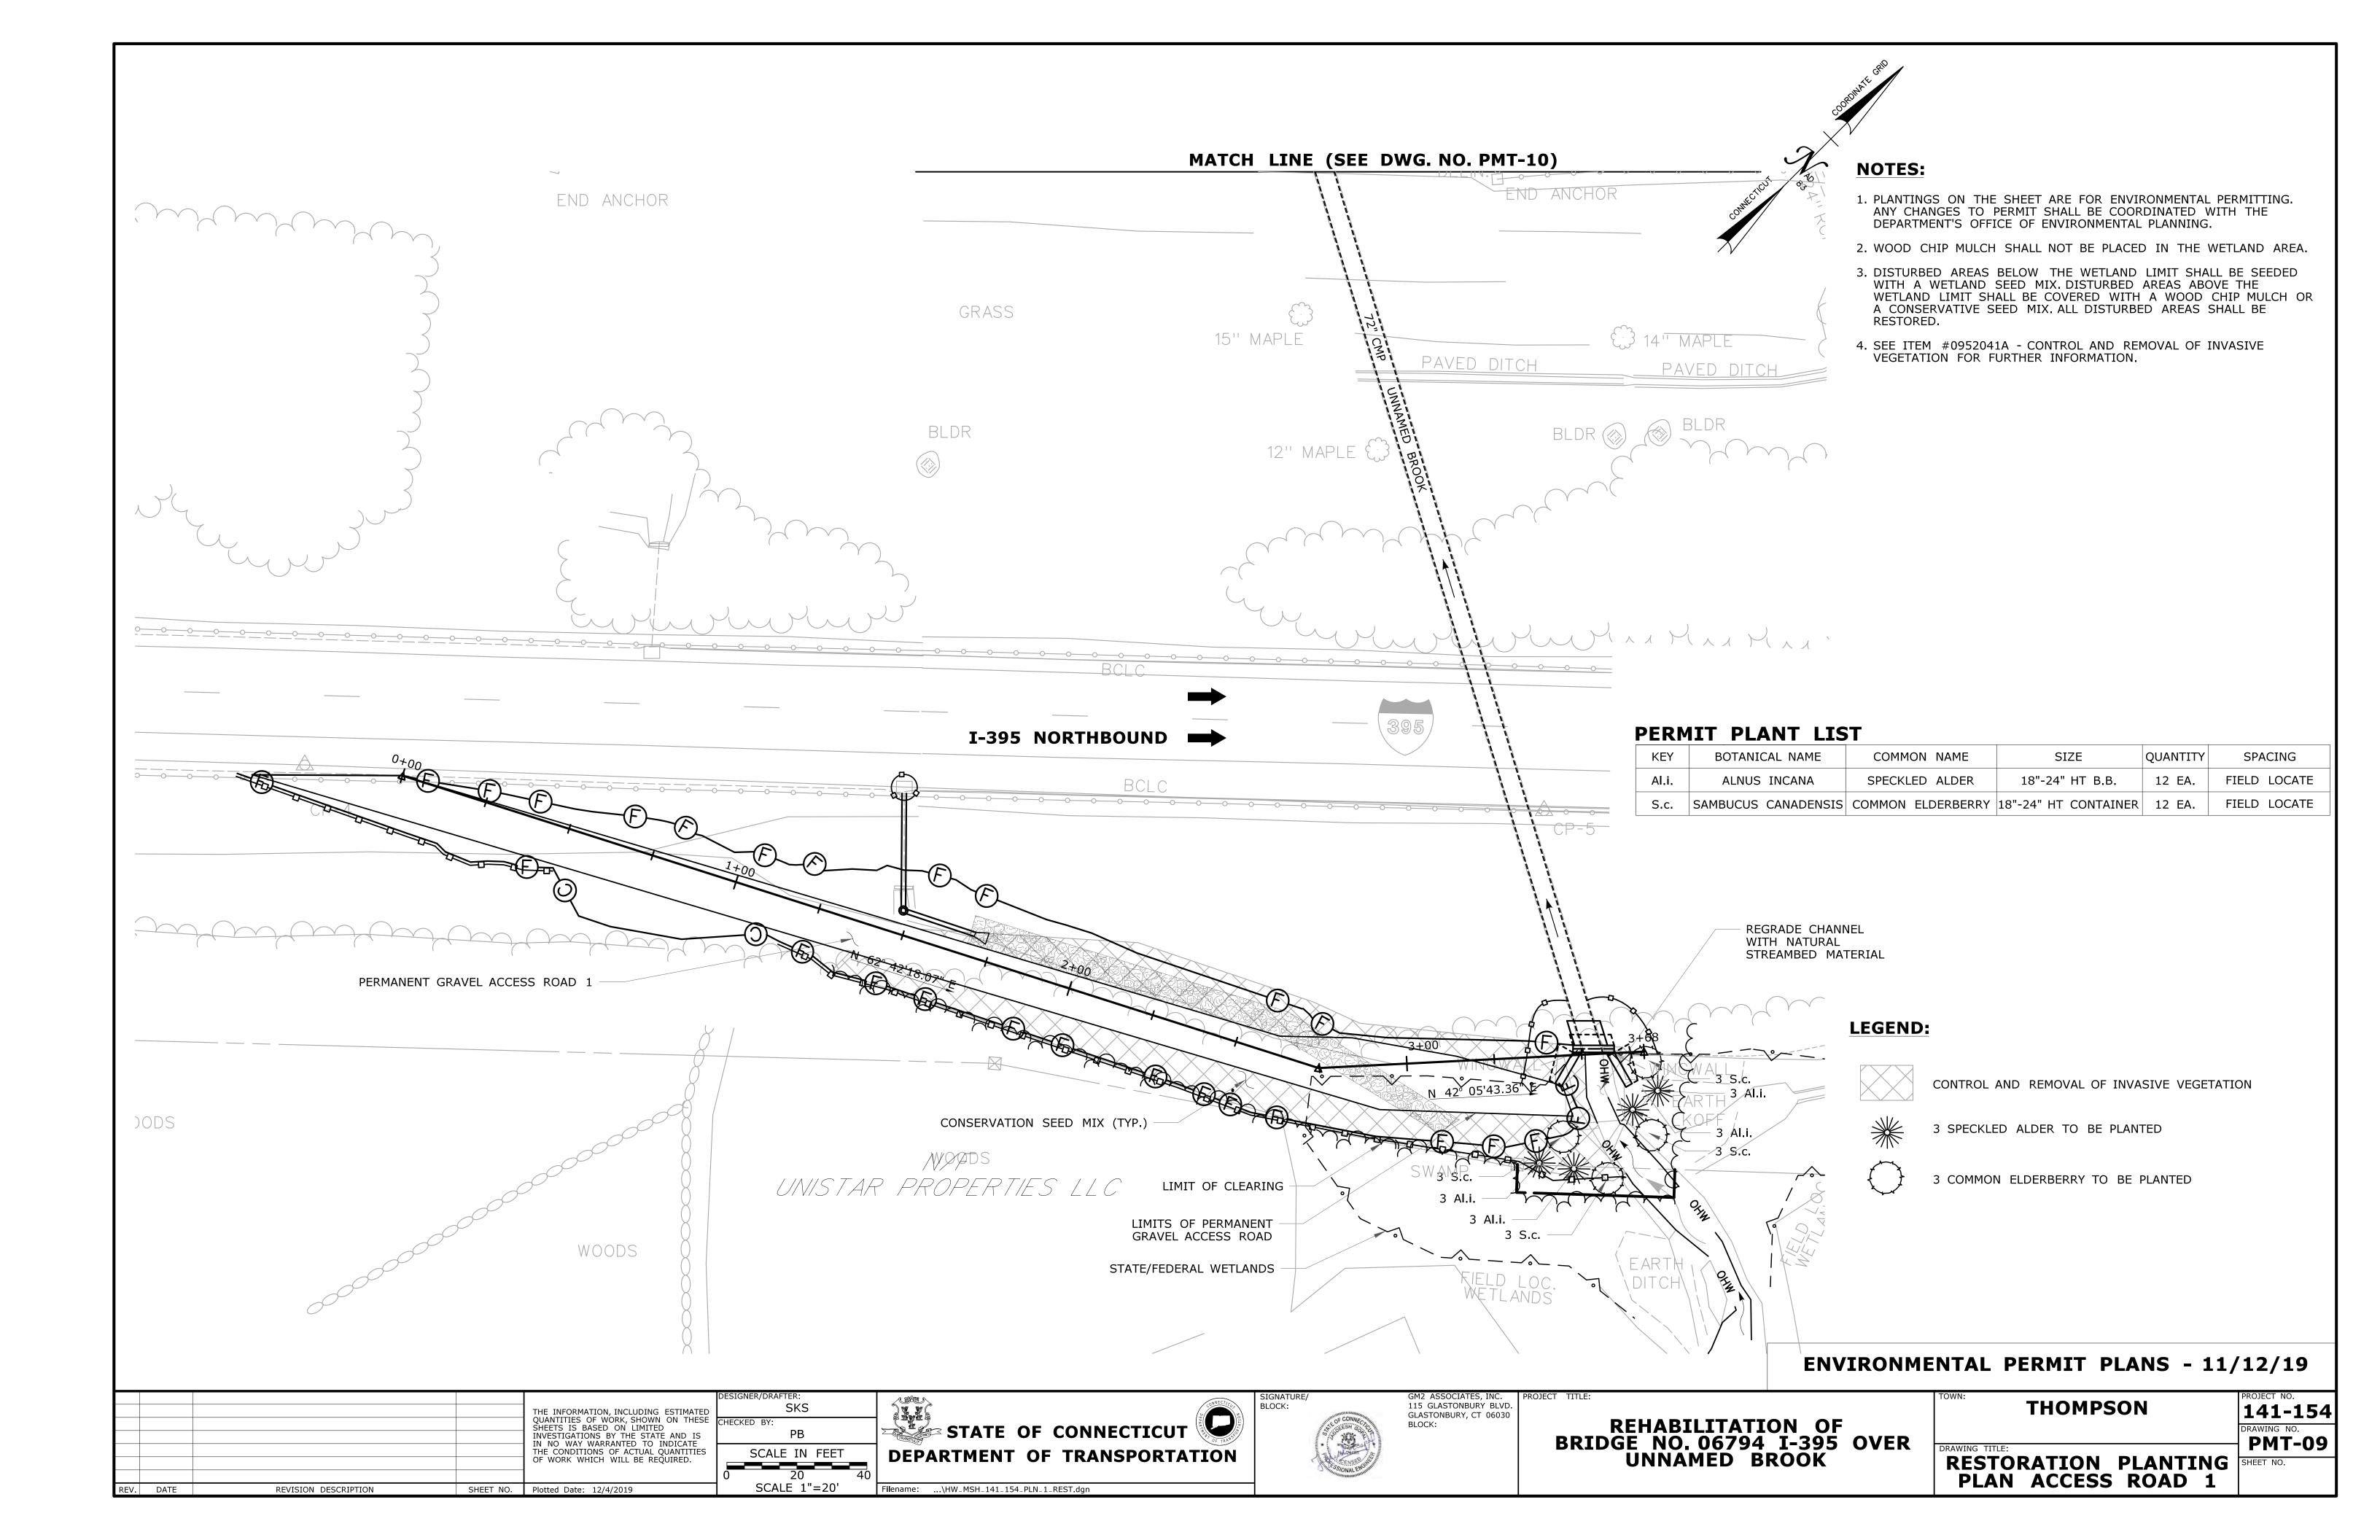

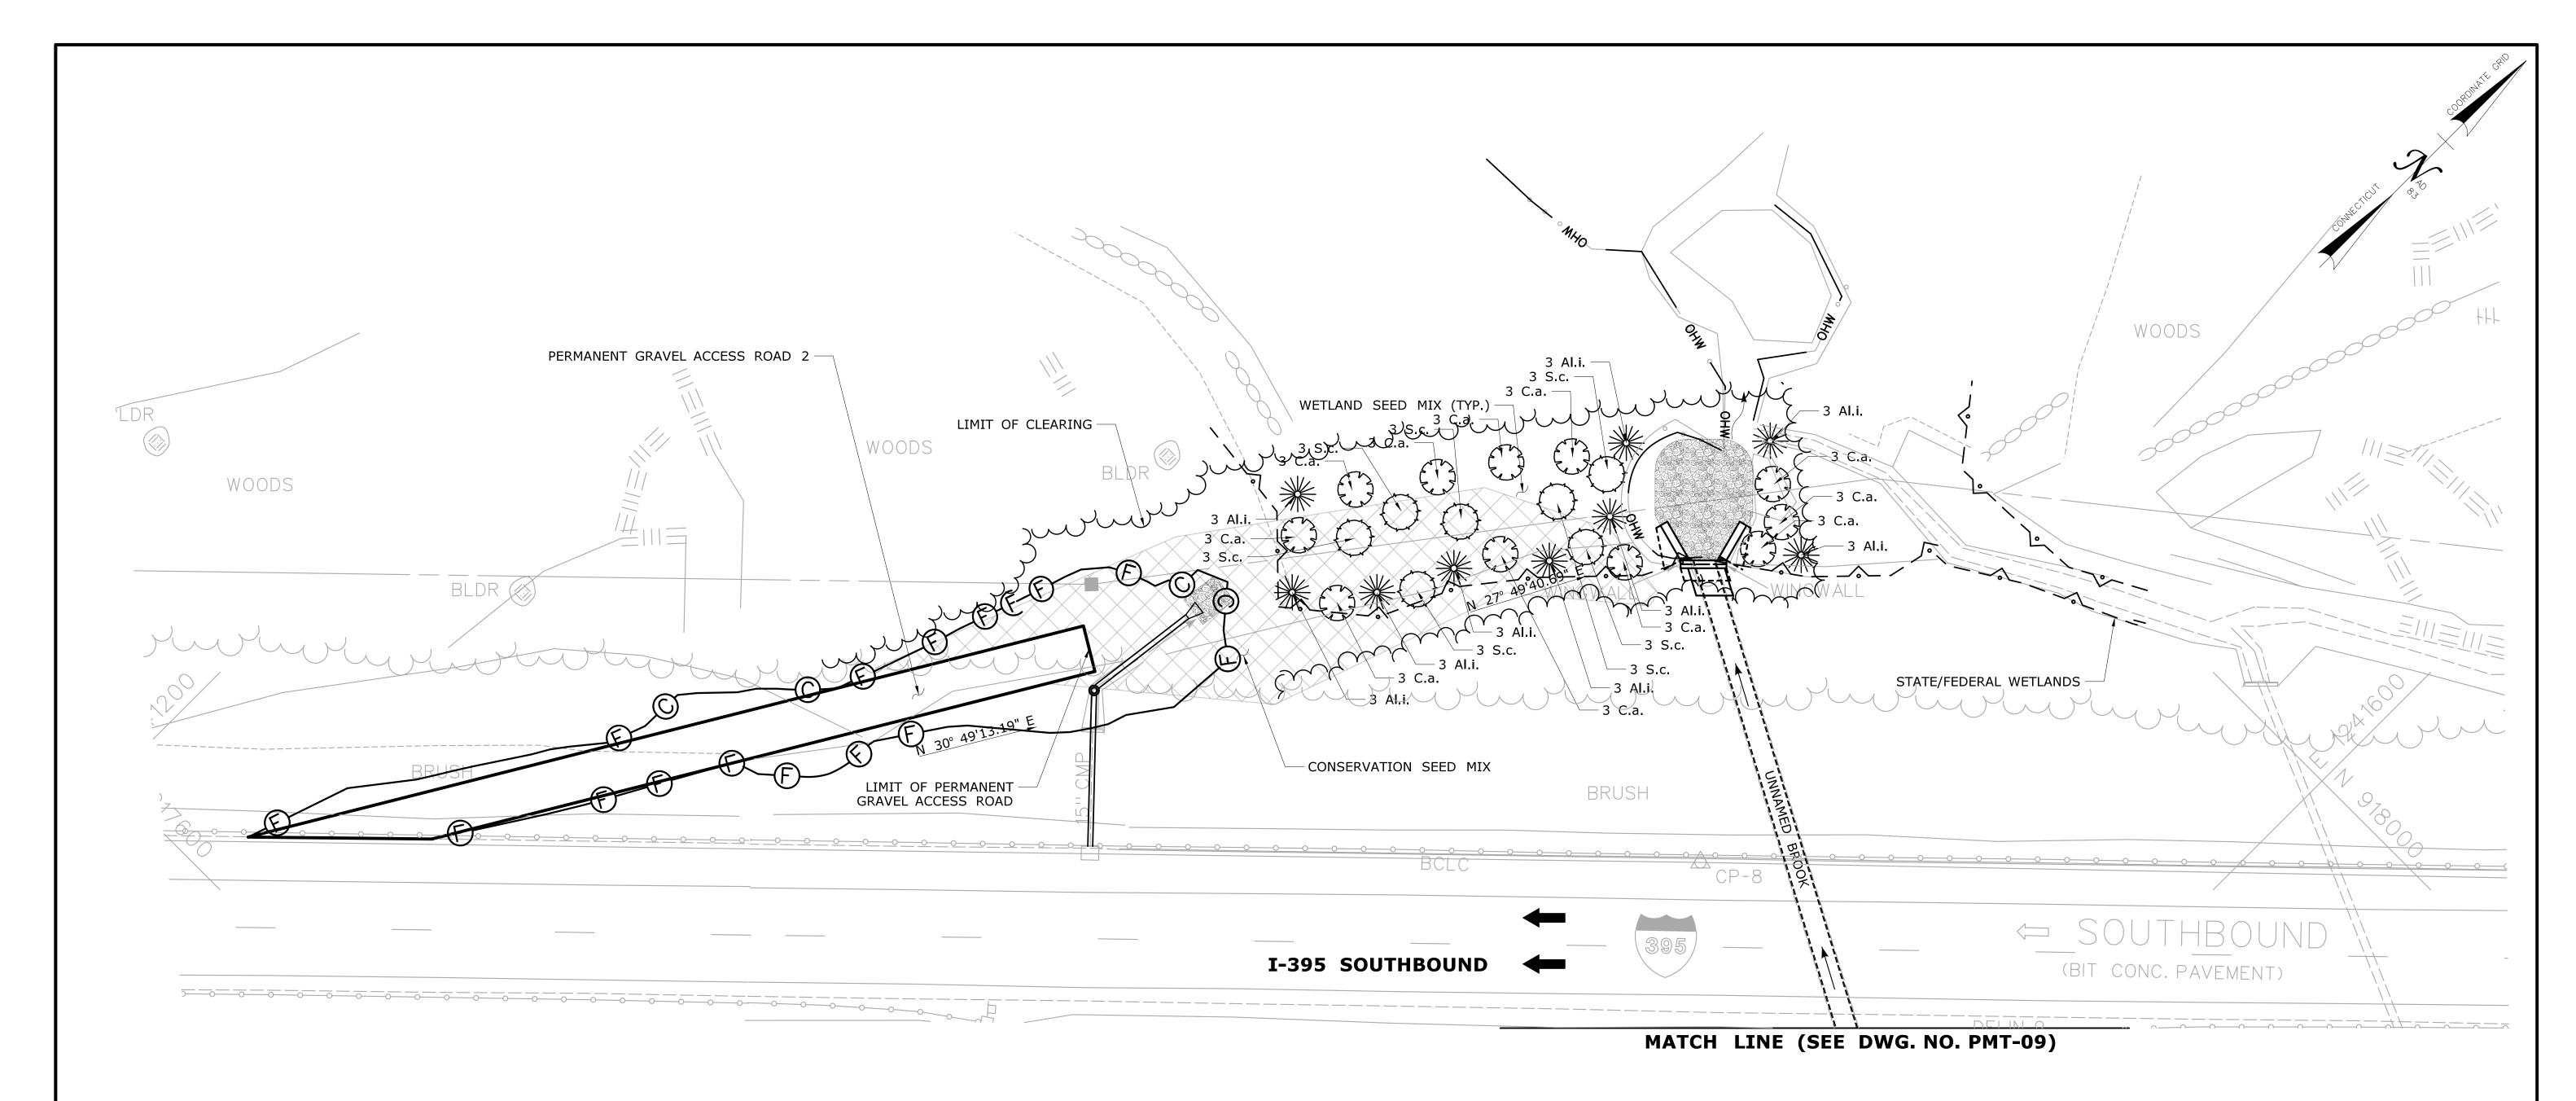

NOTES:

- PLANTINGS ON THE SHEET ARE FOR ENVIRONMENTAL PERMITTING. ANY CHANGES TO PERMIT SHALL BE COORDINATED WITH THE DEPARTMENT'S OFFICE OF ENVIRONMENTAL PLANNING.
- 2. WOOD CHIP MULCH SHALL NOT BE PLACED IN THE WETLAND AREA.
- 3. DISTURBED AREAS BELOW THE WETLAND LIMIT SHALL BE SEEDED WITH A WETLAND SEED MIX. DISTURBED AREAS ABOVE THE WETLAND LIMIT SHALL BE COVERED WITH A WOOD CHIP MULCH OR A CONSERVATIVE SEED MIX. ALL DISTURBED AREAS SHALL BE RESTORED.
- 4. SEE ITEM #0952041A CONTROL AND REMOVAL OF INVASIVE VEGETATION FOR FURTHER INFORMATION.

PERMIT PLANT LIST

KEY	BOTANICAL NAME	COMMON NAME	SIZE	QUANTITY	SPACING
C.a.	CORNUS AMOMUM	SILKY DOGWOOD	18"-24" HT CONTAINER	33 EA.	FIELD LOCATE
Al.i.	ALNUS INCANA	SPECKLED ALDER	18"-24" B.B.	27 EA.	FIELD LOCATE
S.c.	SAMBUCUS CANADENSIS	COMMON ELDERBERRY	18"-24" HT CONTAINER	21 EA.	FIELD LOCATE

LEGEND:

LIMITS OF INVASIVE SPECIES REMOVAL

3 SILKY DOGWOOD TO BE PLANTED



3 SPECKLED ALDER TO BE PLANTED



3 COMMON ELDERBERRY TO BE PLANTED

ENVIRONMENTAL PERMIT PLANS - 11/12/19

141-154

DRAWING NO.
PMT-10

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REV. DATE REVISION DESCRIPTION SHEET NO.	o. Plotted Date: 12/4/2019 SCALE 1"=20'	Filename:\HW_MSH_141_154_PLN_2_REST.dgn		P	CLAIN ACCESS RUAD Z	

Agenda Item I Reports

1 Budget & Expenditures

2 Wetlands Agent Report

Agenda Item J Correspondence

EASTERN CONNECTICUT CONSERVATION DISTRICT, INC.

238 West Town Street Norwich, CT 06360-2111 860-319-8806



139 Wolf Den Road Brooklyn, CT 06234 860-774-9600

BOARD of DIRECTORS

October 27, 2020

OFFICERS

Philip Thomas, Chair, Conservation Commission

William Jorsz Chair

Town of Thompson P.O. Box 899

Sprague

North Grosvenordale, CT 06255

Sherwood Raymond Vice Chair Norwich

Dear Mr. Thomas:

Paul Shaffer Treasurer Norwich

On behalf of the Eastern Connecticut Conservation District, Inc., I am writing to request Thompson's annual support in the amount of \$1,000.00 in your next budget. Attached are a copy of our 2019-20 Annual Report and current year operating budget.

Leonora Szruba Secretary Lisbon

As highlighted in our Annual Report, ECCD responded to over many inquiries from municipalities and residents within our 36-town District. These services are not covered by contracted services. In order to continue many of our technical assistance and educational outreach programs, we are required to seek additional sources of

funding.

DIRECTORS

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ALTERNATES

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> Lydia Pan Mystic

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ECCD works in eastern CT from the Massachusetts border to the coastal towns along Long Island Sound. ECCD's primary focus is to improve water quality by reducing nonpoint source pollution. Improving water quality generally improves our drinking water and local waterbodies for swimming, fishing and recreation. Additionally, the work we do improves the water quality of the beaches and coastal embayments in southeast Connecticut, which is important for summer recreation and shellfishing.

Support from Thompson would serve to enhance the number of people we can provide continuing natural resource conservation services for throughout eastern Connecticut. Awareness and action continue to grow, as more and more people strive to practice sound conservation measures for their towns and properties.

We encourage you to read through our Annual Report and visit our website at www.ConcserveCT.org/eastern to learn more about our non-profit organization.

If you have any questions or require any additional documentation, please contact our Office Manager, Francine Brodeur, at 860-319-8806 or at

Francine.eccd@comcast.net. Thank you for your consideration of our request.

Sincerely,

William A. Jorsz

Chair

Enc.: 1 packet

Agenda Item K Signing of Mylars

Agenda Item L Comments by Commissioners

Agenda Item M Adjournment