



170,000 ton
Cubic yds 113,333

TOWN of
THOMPSON
PLANNING AND ZONING COMMISSION

FOR OFFICE USE ONLY

Fee Paid/Date: \$ 2,326.00
 _____ Cash _____ Check 1898 Ck. #)

Application Submission Date: 5-15-2020
 Date Received by Commission: 5-26-2020
 Application #: 20-11

20-11

APPLICATION FOR ZONING REVIEW

- Special Permit
- Zone Change
- Site Plan
- Accessory Apartment

- Gravel Mining RENEWAL
- Country Inn Permit
- Text Amendment
- Other

DEED INFORMATION: Volume _____ Page _____ Map 63 Block 58 Lot 157 Zone R40

Location of Property: 659 Riverside Dr

Applicant(s) Name: North East Sand & Gravel

Mailing Address 1880 Providence Rd. North Bridge MA. 01534

Telephone (508) _____ Business Telephone (508) 962-1993

Email Address JRMJR @ Hotmail.com

Owner(s) of Record John MERCIER

Mailing Address 1880 Providence Rd. North Bridge MA. 01534

Telephone (508) 962-1993 Business Telephone (508) -656-0637

Email Address JRMJR @ Hotmail.com

Type of Sewage Private Public

Type of Water Supply Private Public

Is Subject Property in an Aquifer Protection Zone Yes No If yes, please include form _____

Is the Subject Property located within a Flood Zone Yes No If yes, copy of FIRM required

Wetlands Permit Required Yes No If yes, attach proof of approval

NDDH Approval Required Yes No If yes, attach proof of approval

Description of Request: Renewal of Sand & Gravel operation

Signature of Property Owner [Signature] Date 5/15/20

Signature of Applicant [Signature] Date 5/15/20

FOR OFFICE USE ONLY:

Date of PZC Meeting 5/26/2020 Date of Public Hearing: 5

Approved Yes No Date _____

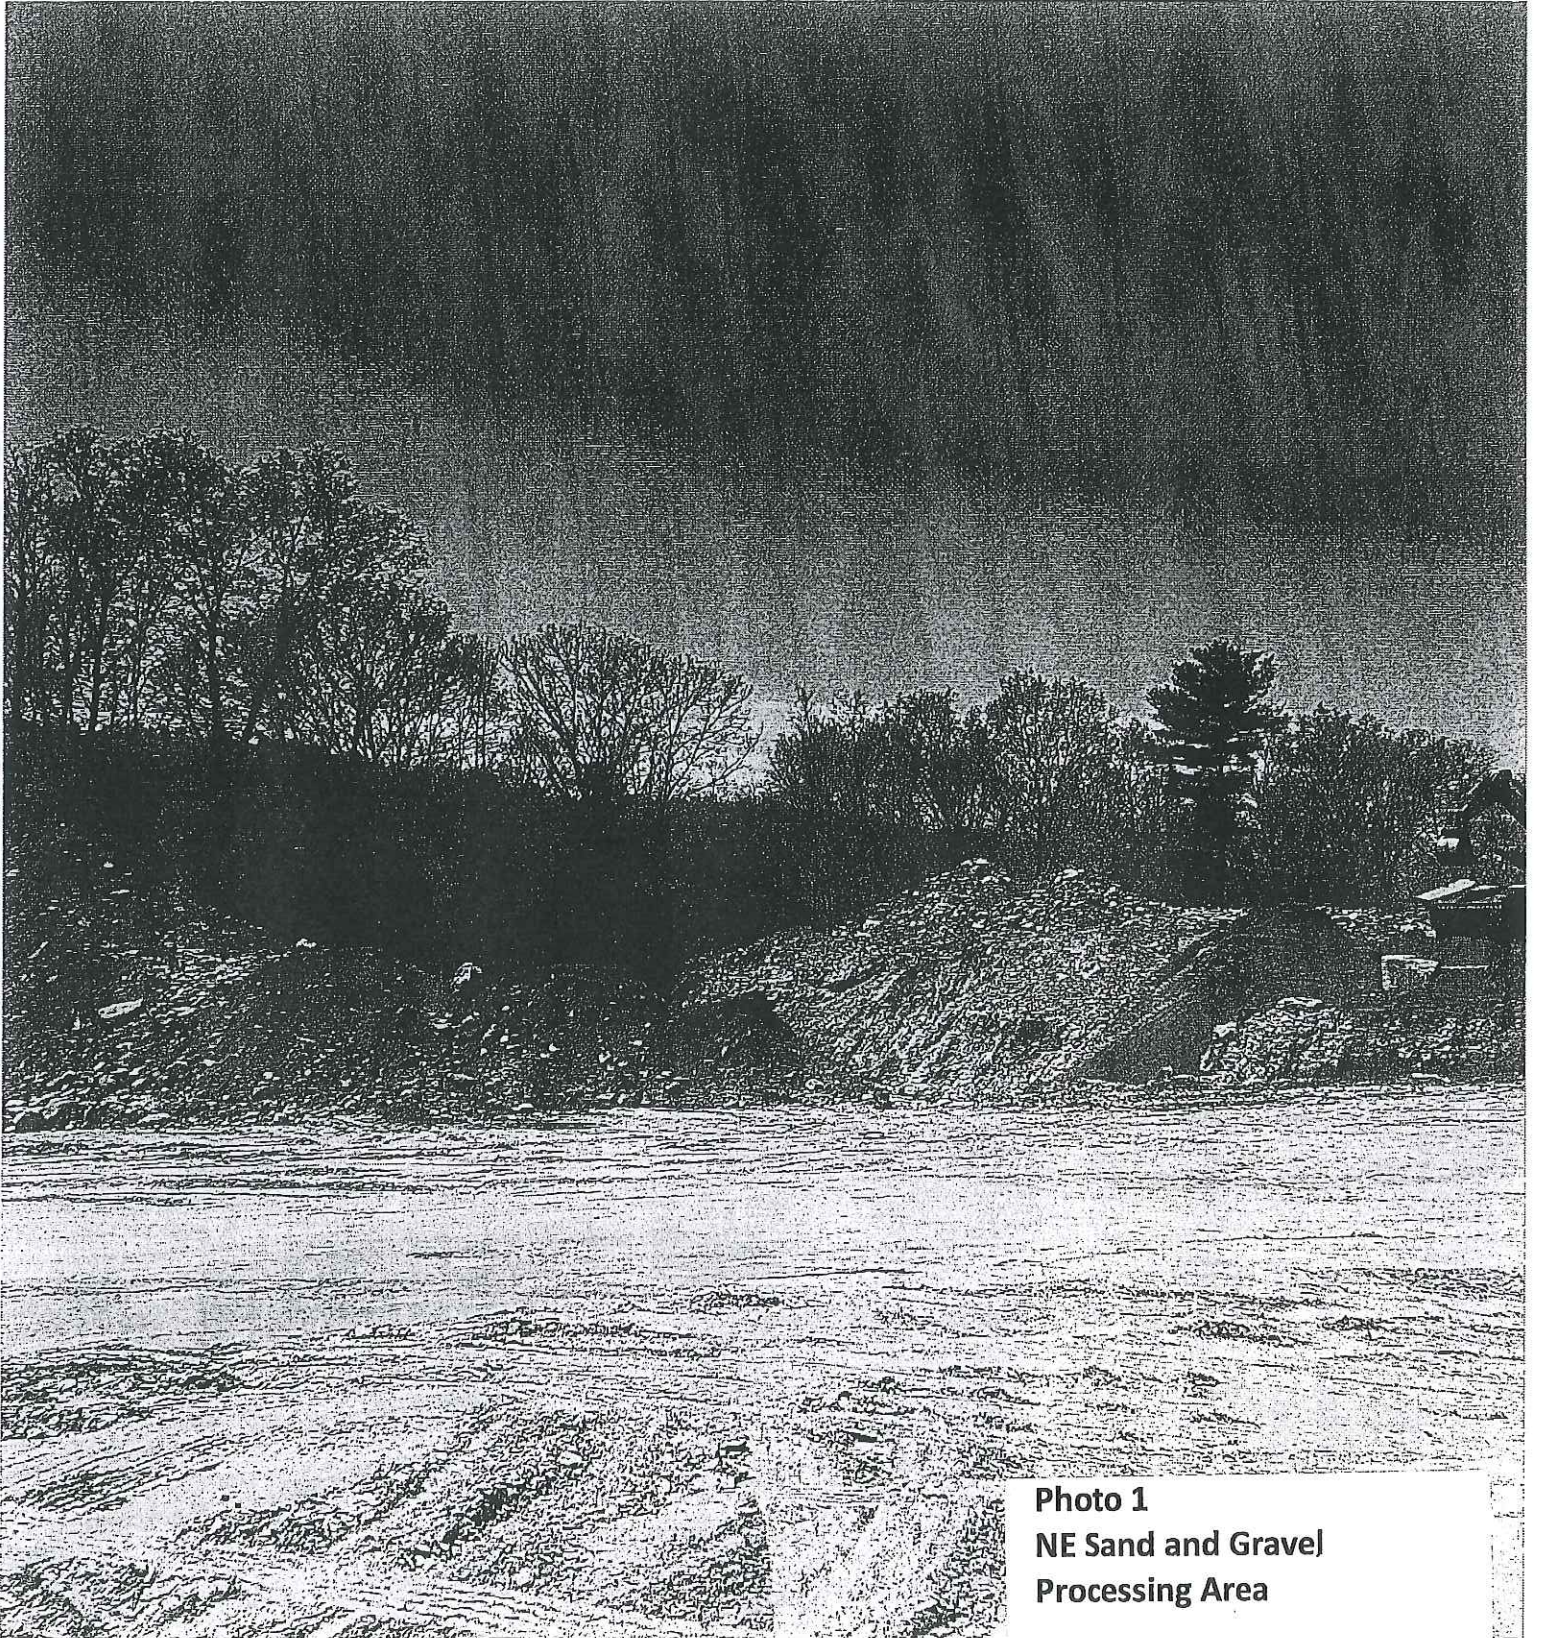


Photo 1
NE Sand and Gravel
Processing Area

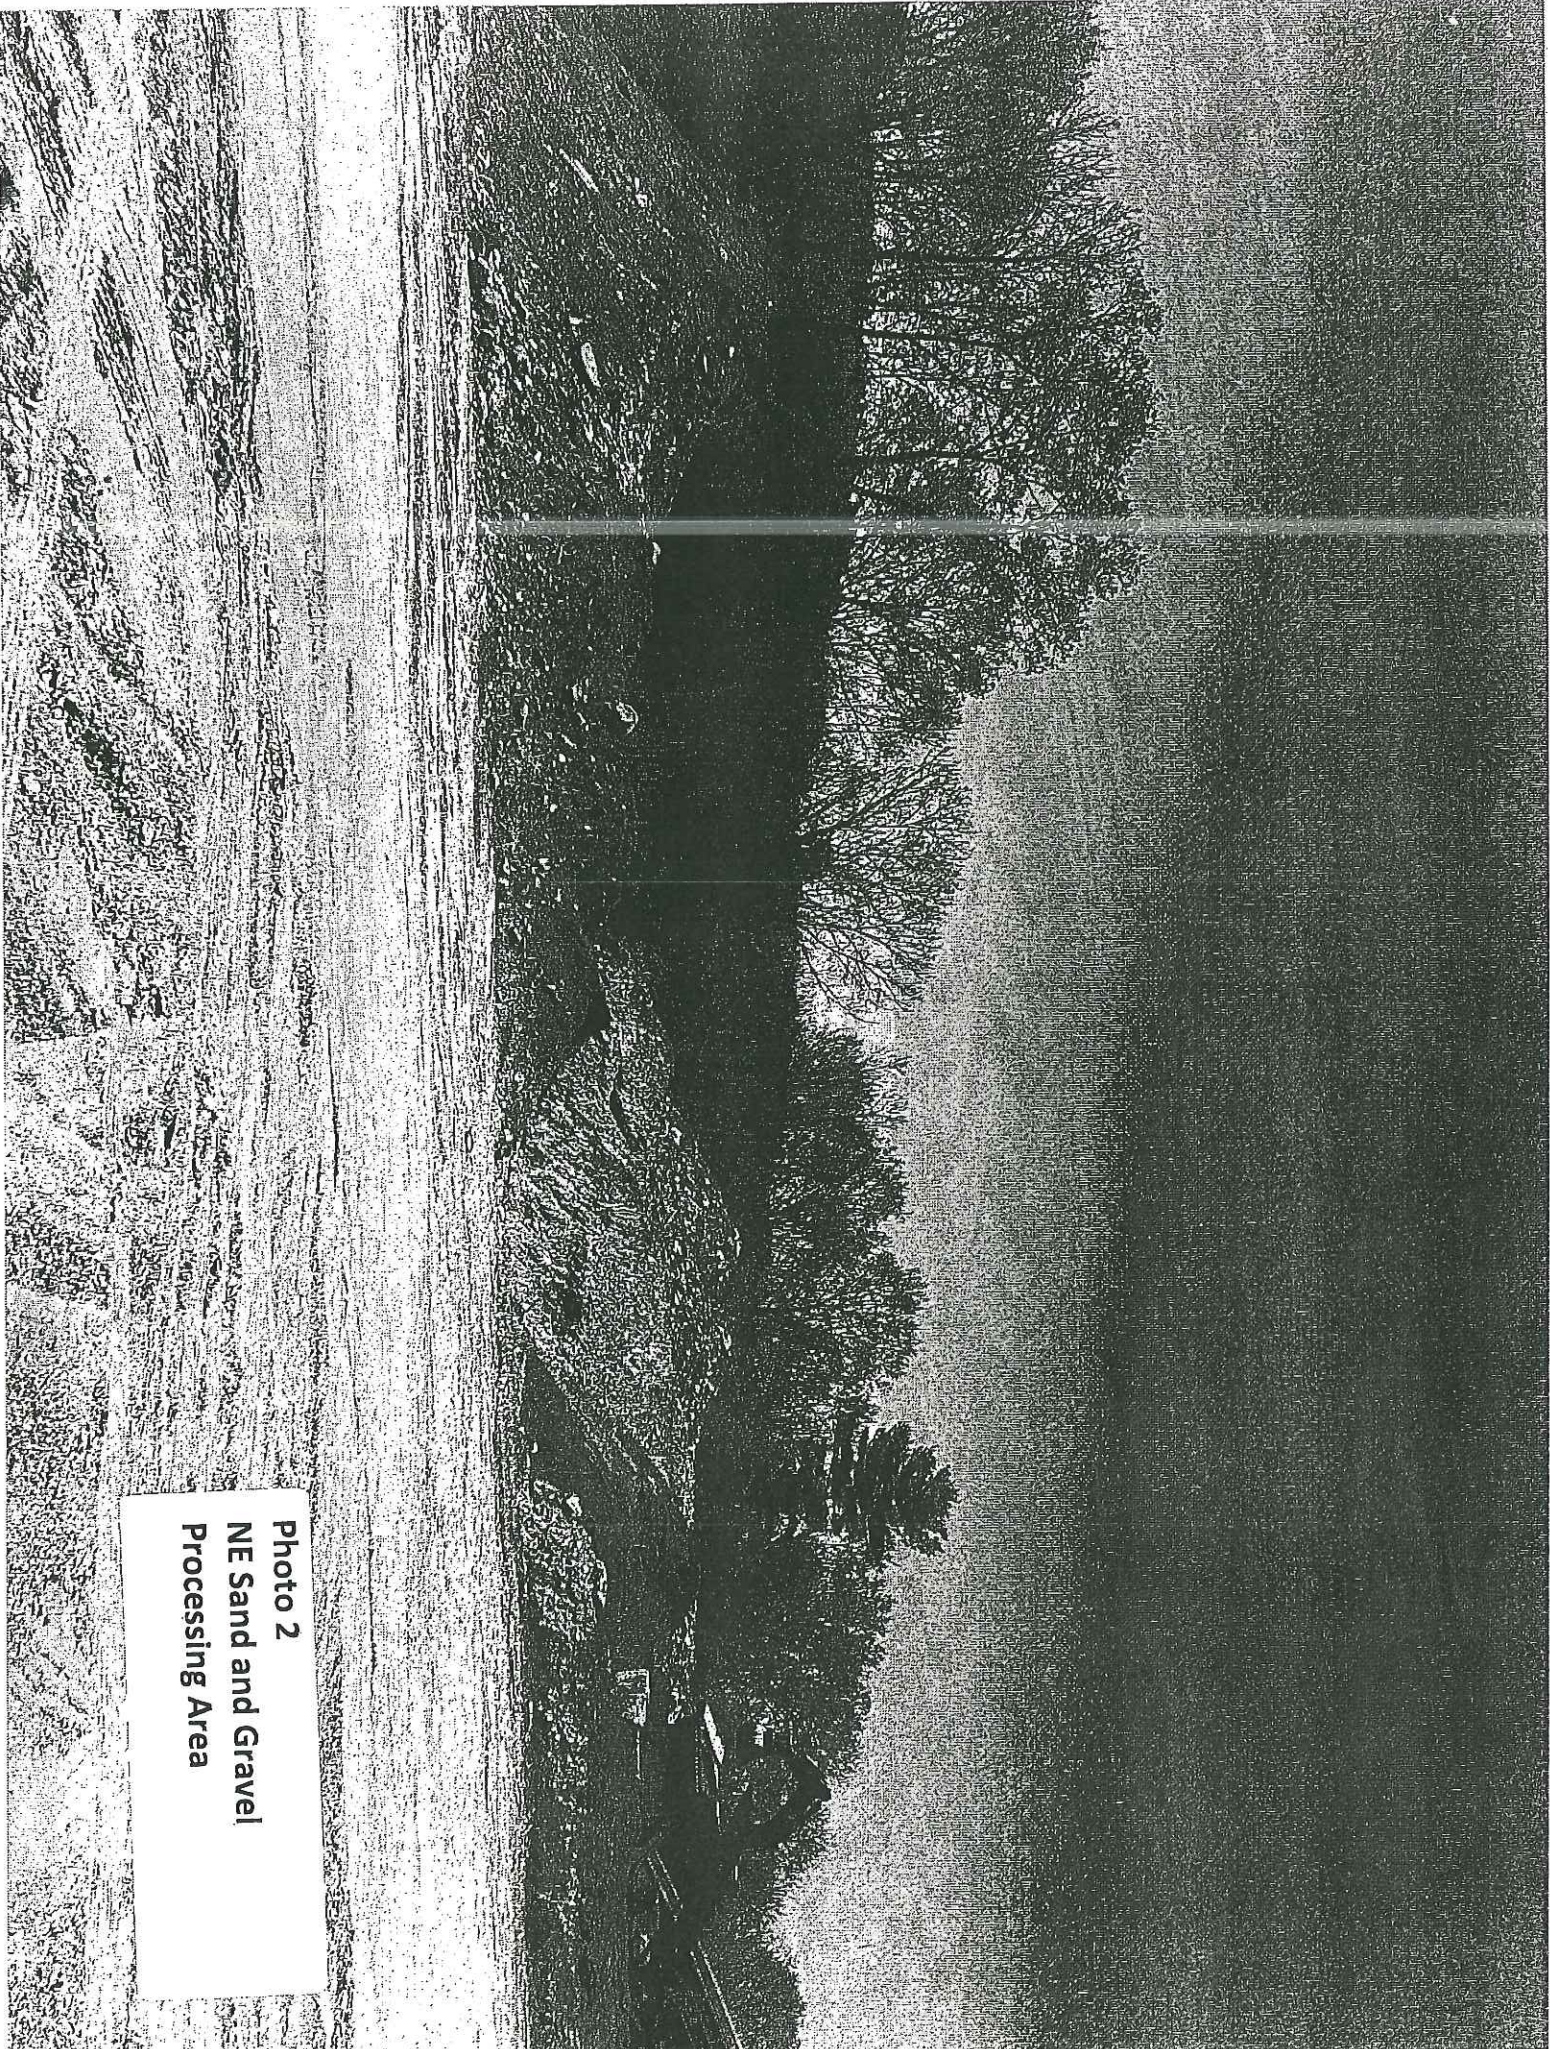


Photo 2
NE Sand and Gravel
Processing Area



Photo 3
NE Sand and Gravel
Processing Area



Photo 4
NE Sand and Gravel
Stockpile

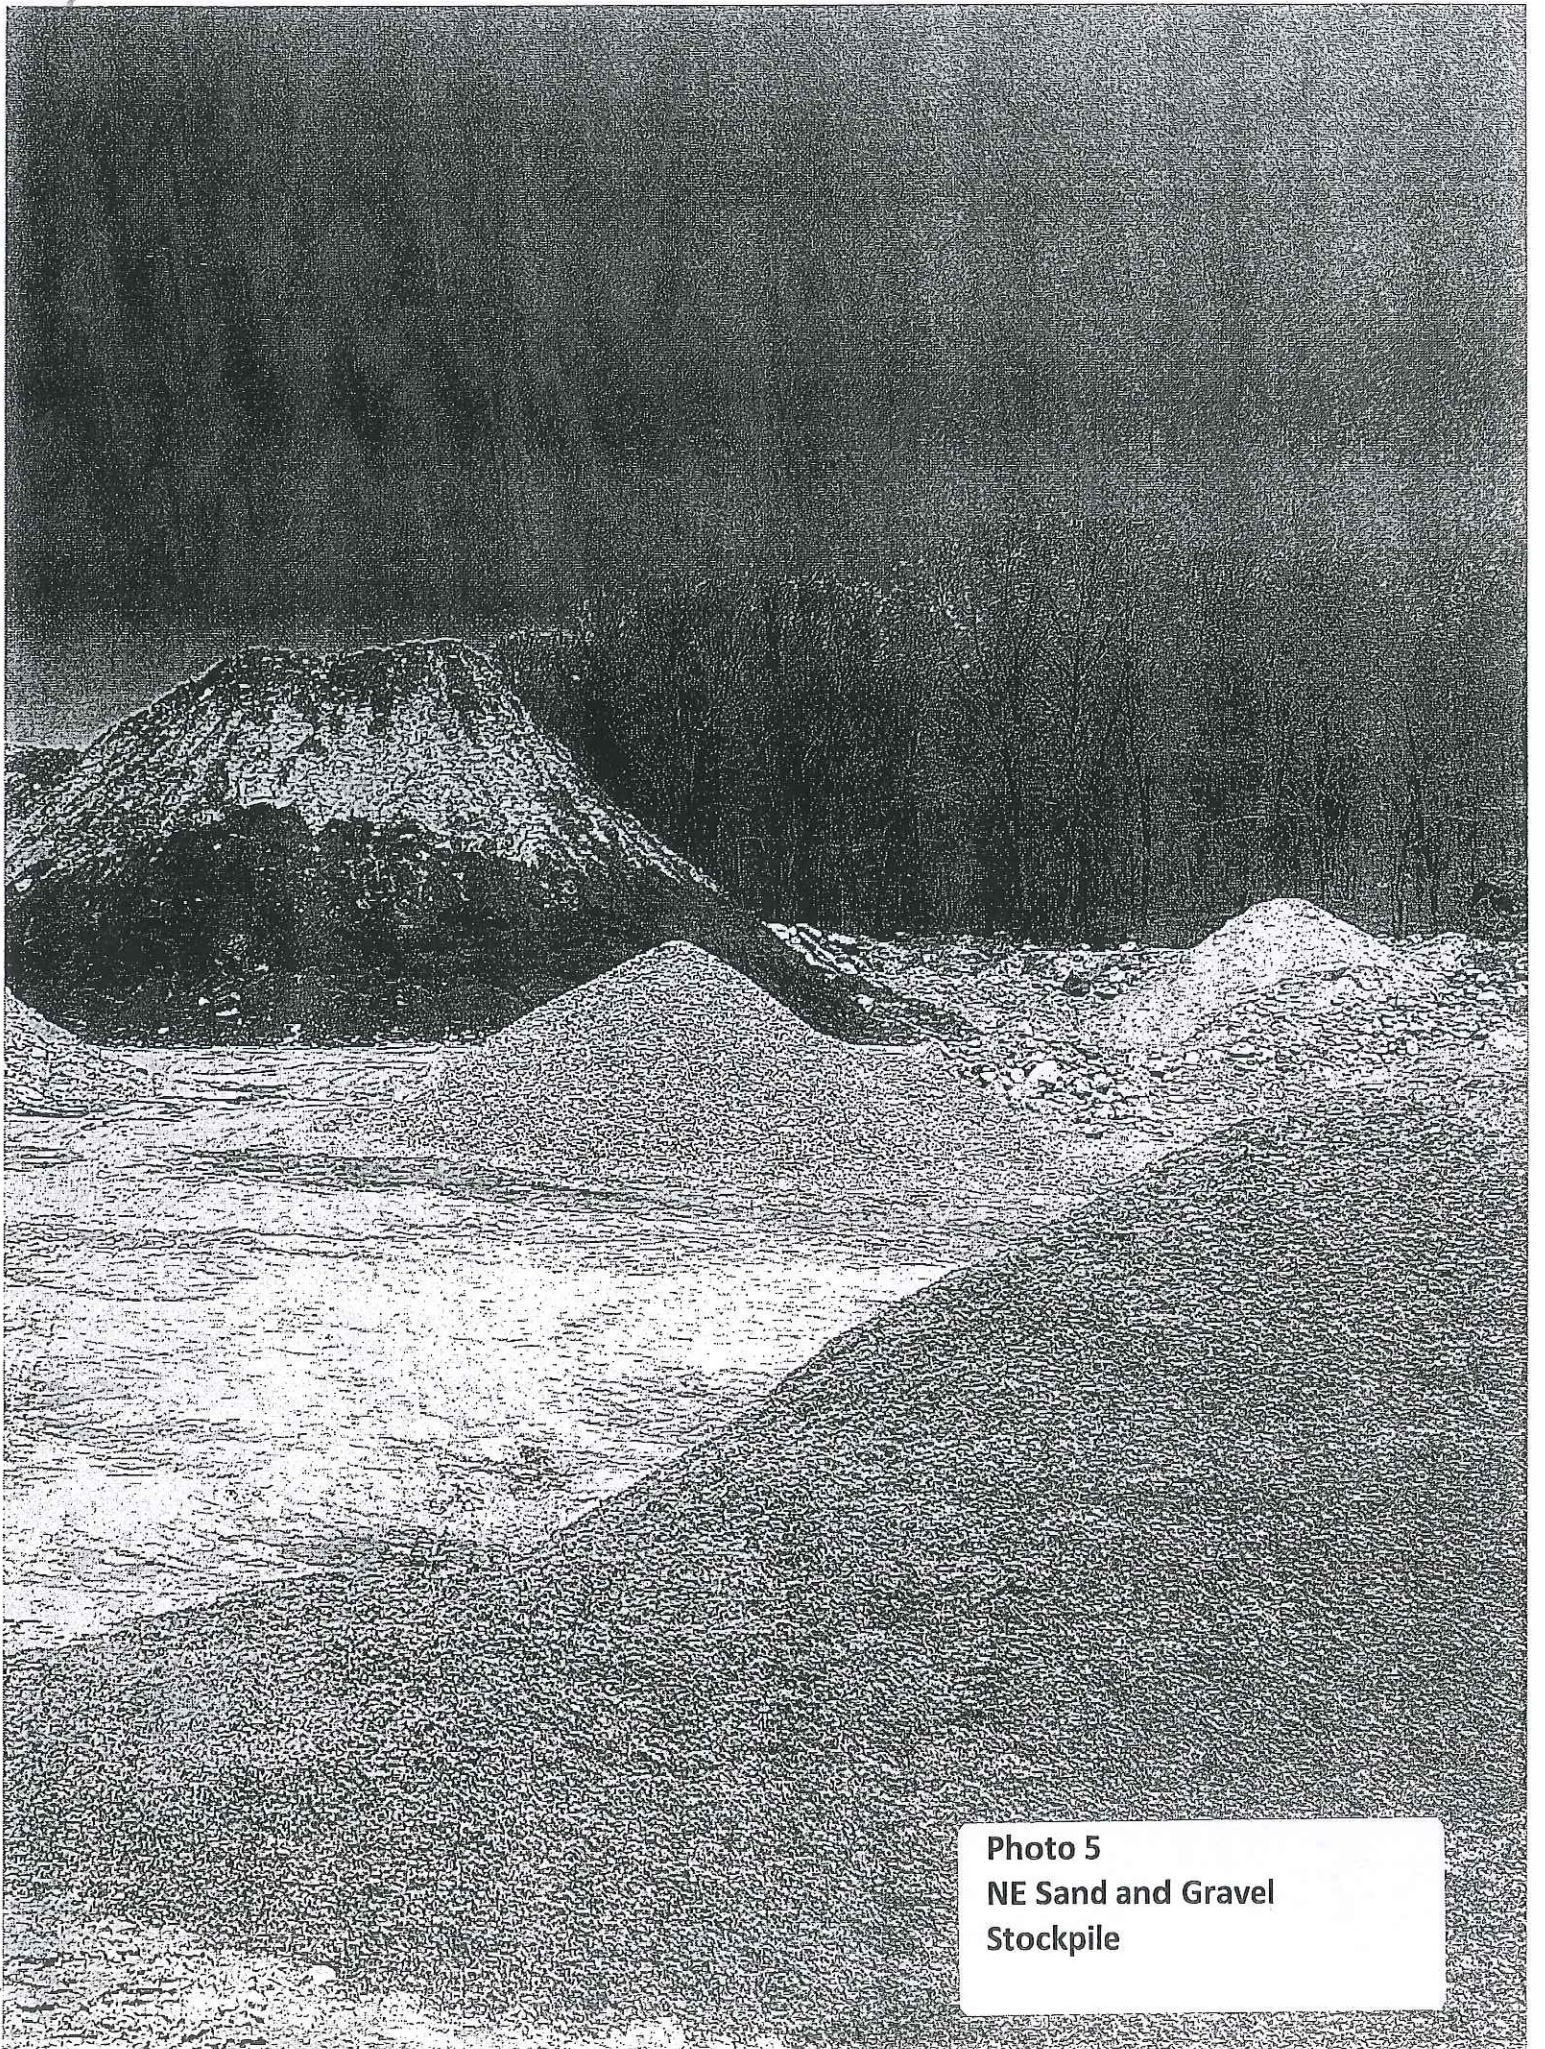


Photo 5
NE Sand and Gravel
Stockpile



Photo 6
NE Sand and Gravel
Stockpile

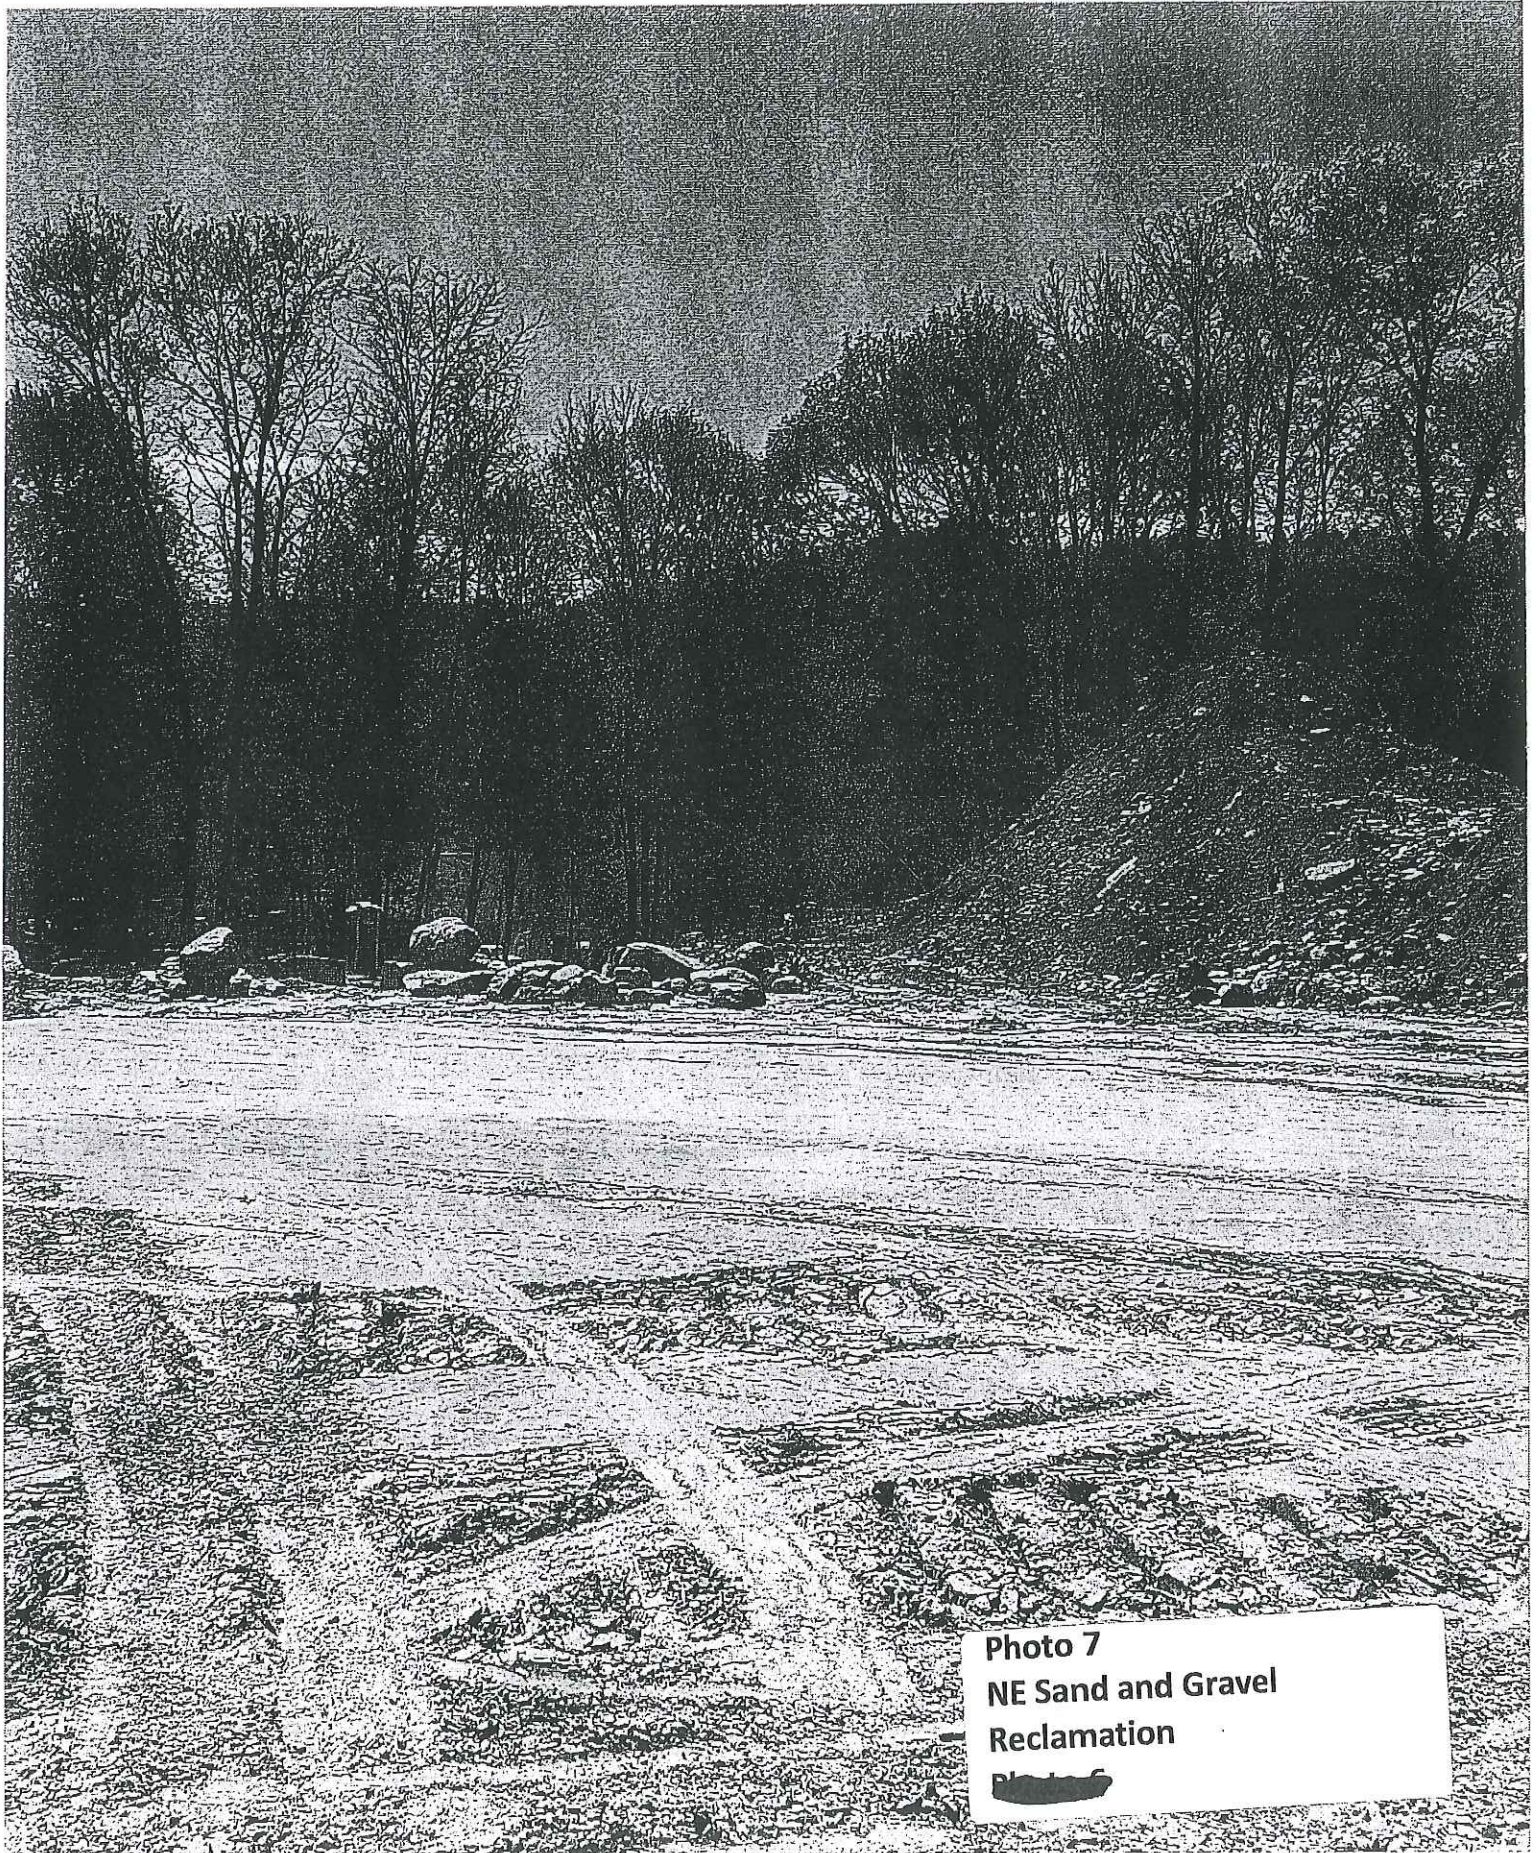


Photo 7
NE Sand and Gravel
Reclamation

Photo 6



Photo 8
NE Sand and Gravel
Reclamation

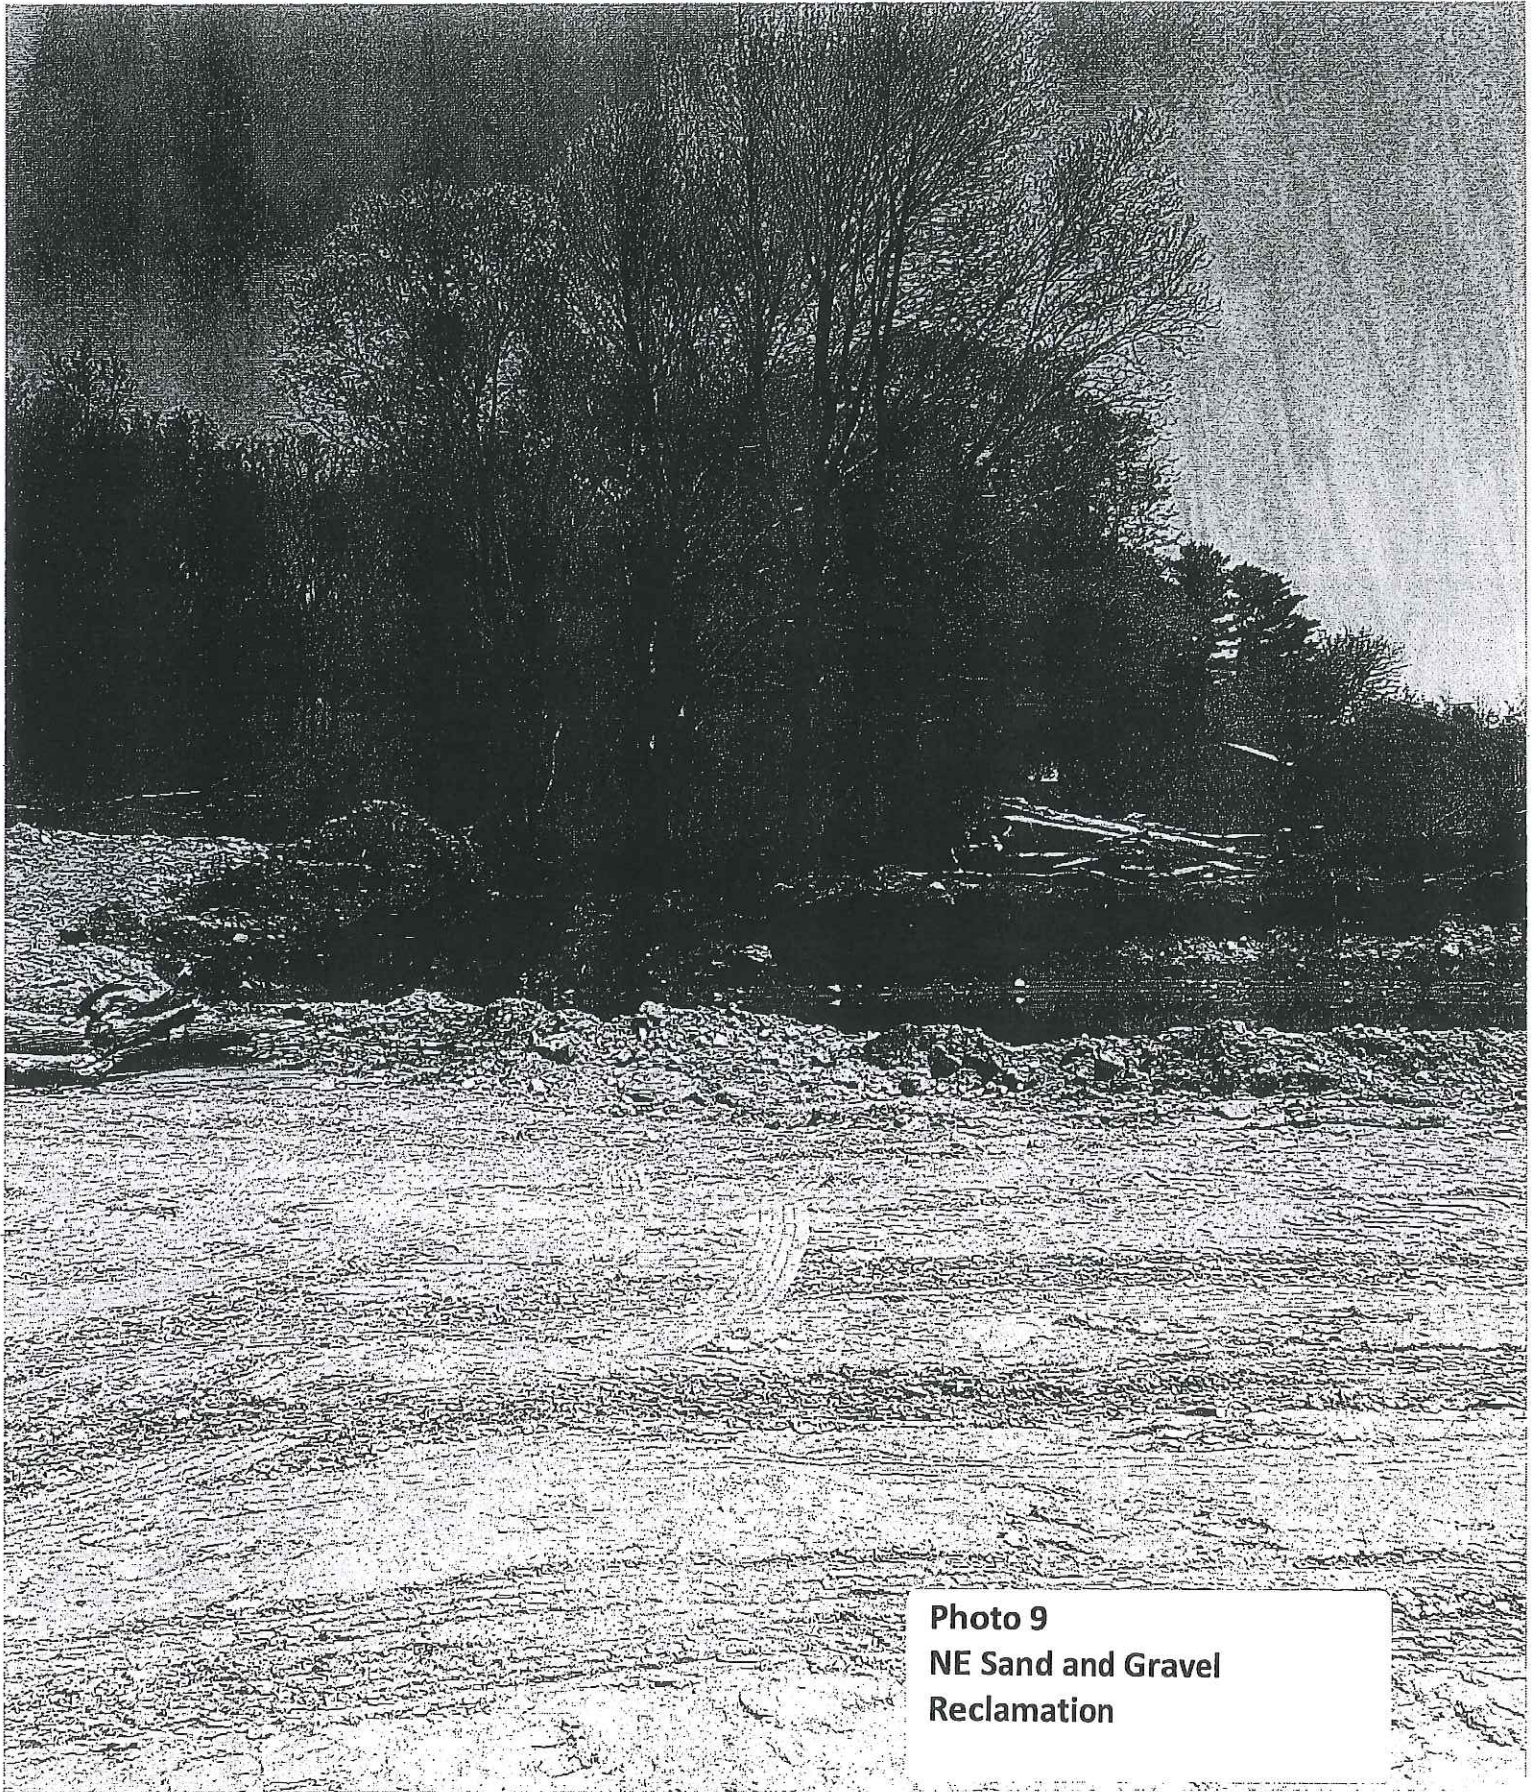


Photo 9
NE Sand and Gravel
Reclamation

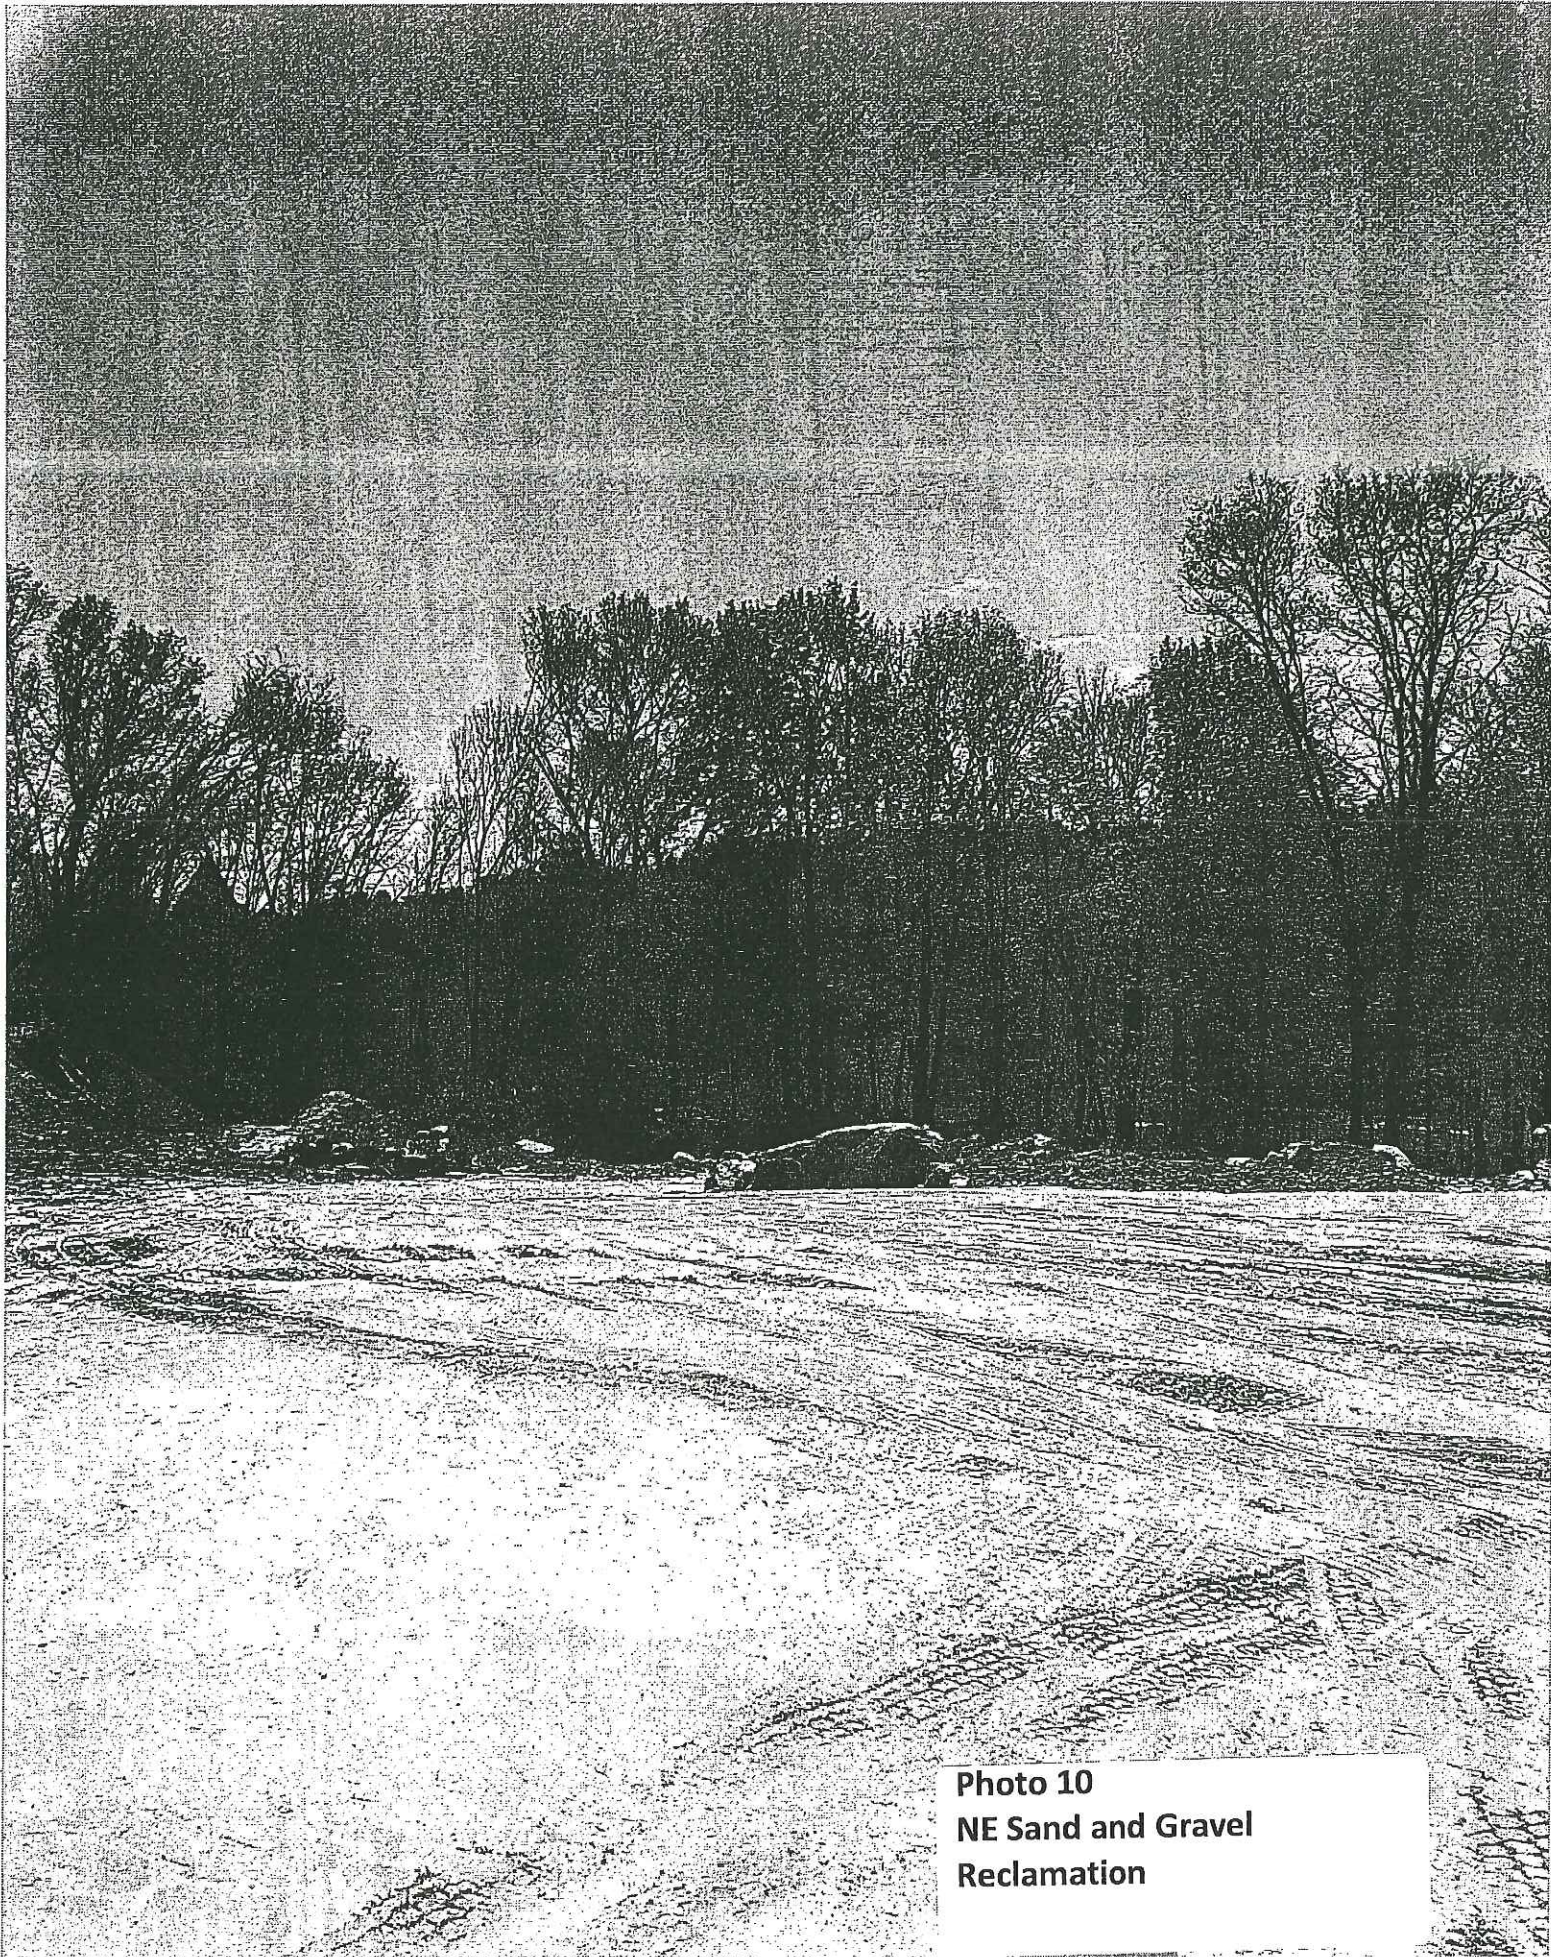


Photo 10
NE Sand and Gravel
Reclamation

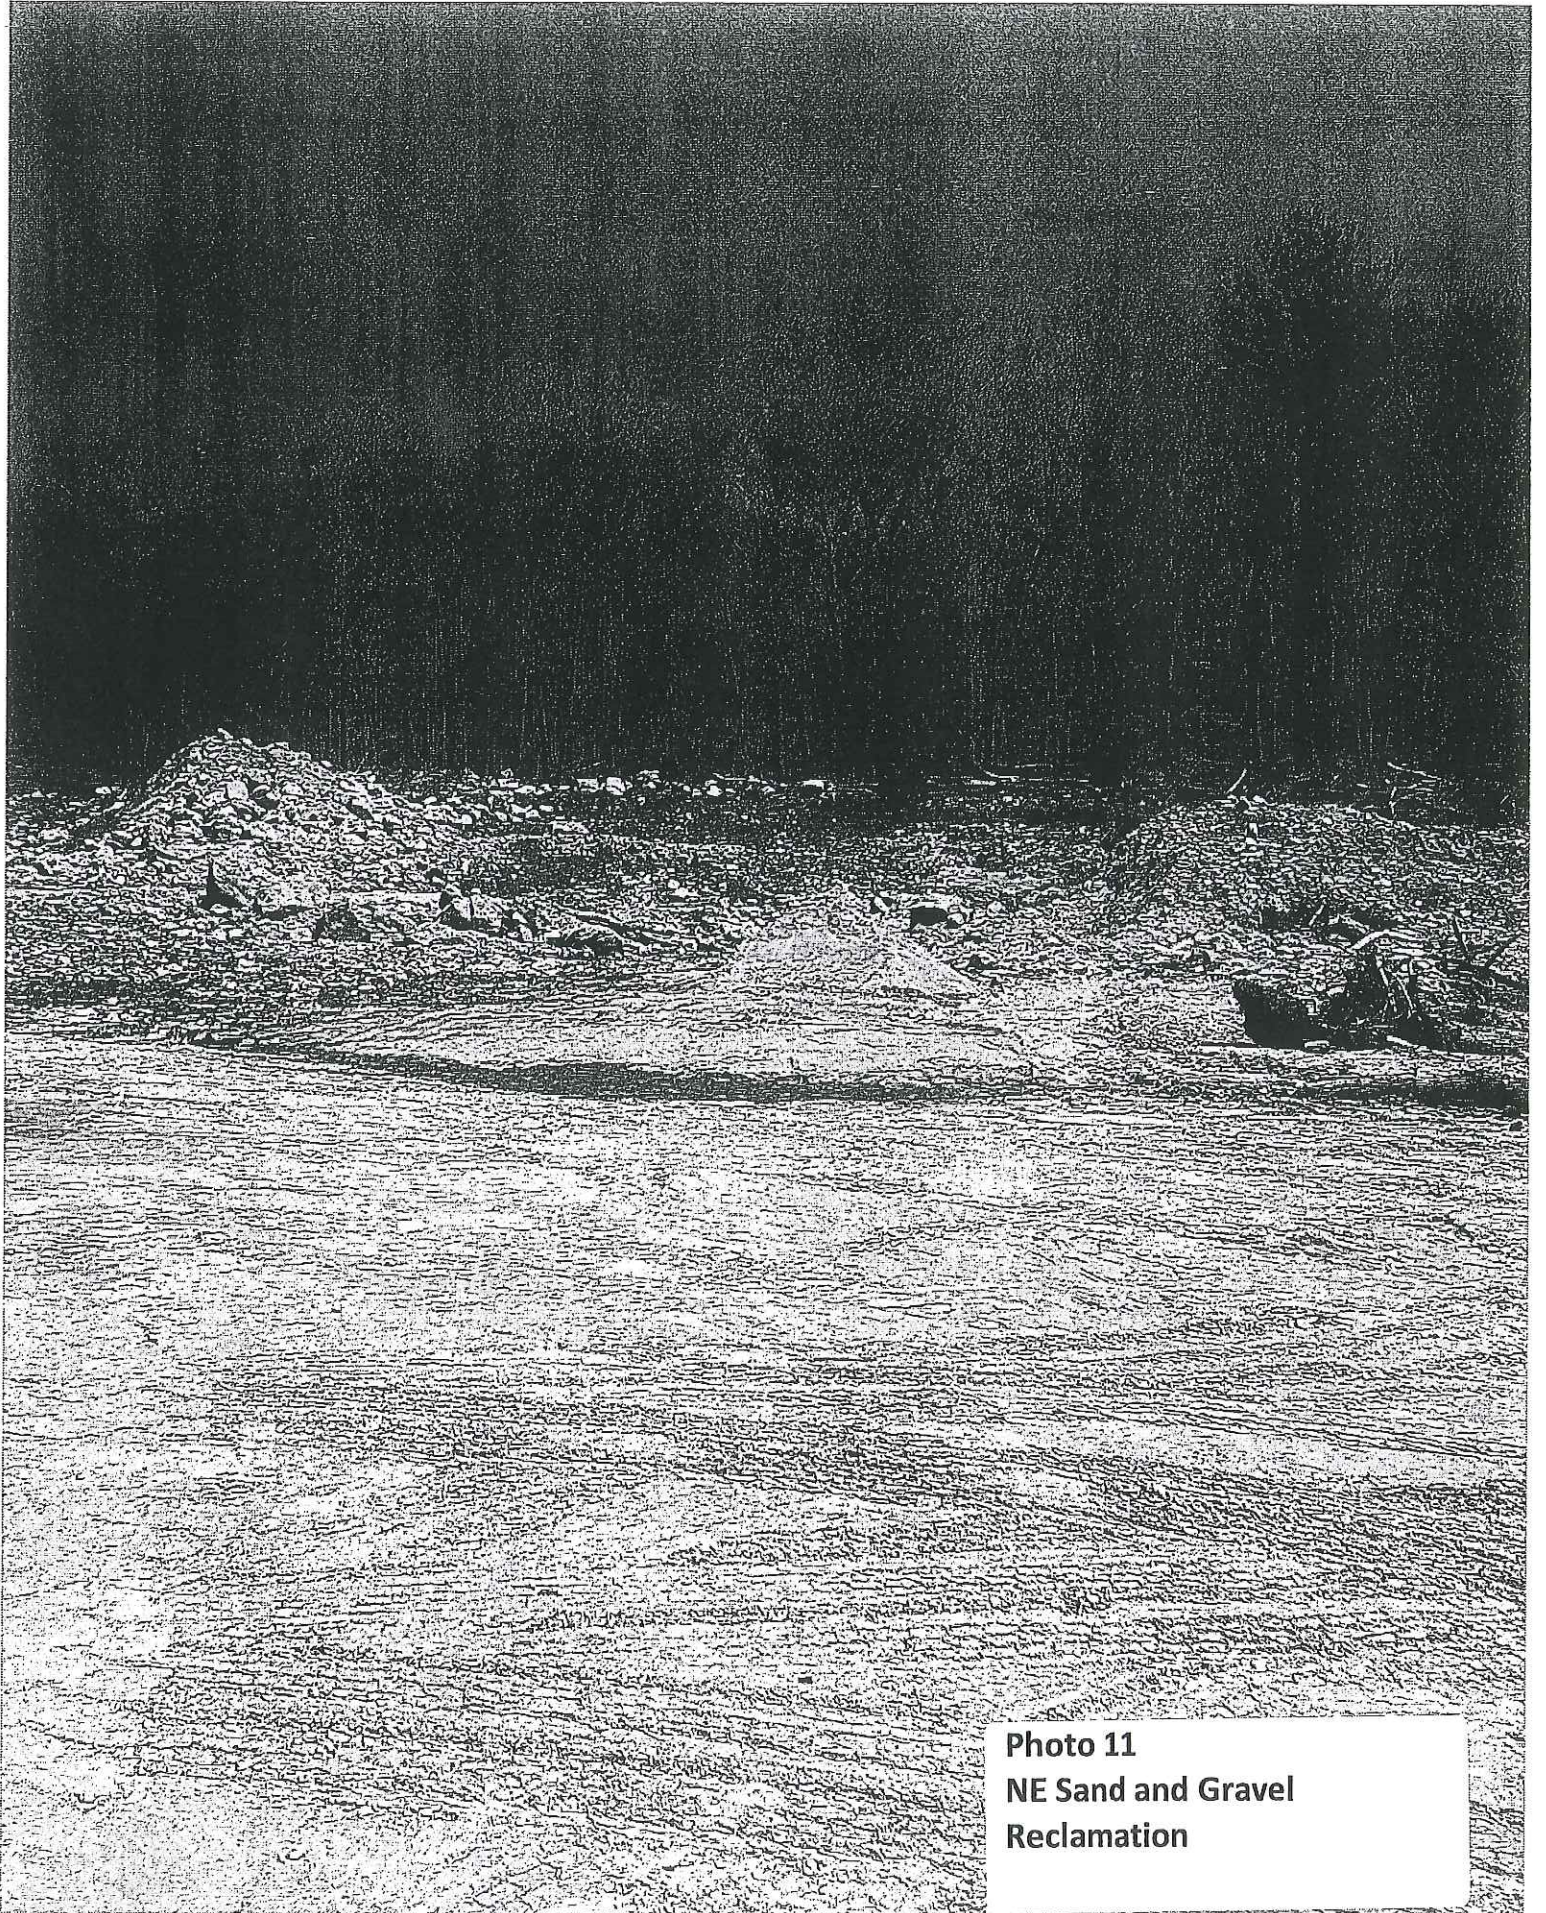


Photo 11
NE Sand and Gravel
Reclamation

JOB NO: 08230		SCALE: 1" = 100'
DATE: DECEMBER 2005		SHEET: 10
DRAWN: LAL		DESIGNED: JAB
3-07-06		
2-06		J&D CIVIL ENGINEERS 401 RIVERIDE ROAD ROSELAND, CT 06468
REVISIONS:		
PREPARED FOR 200 ASSOCIATES ROUTE 12, ROUTE 200, THATCHER ROAD AND MASON TERRACE - THOMPSON, CT		
SOIL MAP AND EARTH EXCAVATION PLAN		

- SOIL MAP AND EARTH EXCAVATION PLAN**
PREPARED FOR 200 ASSOCIATES
ROUTE 12, ROUTE 200, THATCHER ROAD AND
MASON TERRACE - THOMPSON, CT
1. TOTAL SITE AREA - 57.4 ACRES
2. EXCAVATION AREA - 13.8 ACRES
PHASE 1 - 2.5 ACRES
PHASE 2 - 2.4 ACRES
PHASE 3 - 2.4 ACRES
PHASE 4 - 6.5 ACRES
3. QUANTITY OF EXCAVATION: 275,000 CUBIC YARDS
4. FINISH SURFACE WILL NOT EXCEED ±1 EXCEPT WHERE SHOWN OTHERWISE
5. THE ACCESS ROAD WILL BE WIDENED DOWN ON CENTERLINE TO THE DRIVE ON THE PROPOSED SUBDIVISION ROAD
6. THE EXCAVATION SHALL BE DIVIDED IN BOTH ACCESS ROADS AND THROUGH ROADS AS NECESSARY TO MAINTAIN BEST INTERFERE WITH TRAFFIC
7. THE ACCESS ROAD WILL BE 20' WIDE AT THE DRIVE
8. THE EXCAVATION SHALL BE DIVIDED IN BOTH ACCESS ROADS AND THROUGH ROADS AS NECESSARY TO MAINTAIN BEST INTERFERE WITH TRAFFIC
9. THE EXCAVATION SHALL BE DIVIDED IN BOTH ACCESS ROADS AND THROUGH ROADS AS NECESSARY TO MAINTAIN BEST INTERFERE WITH TRAFFIC
10. EXCAVATION SHALL BE DIVIDED IN BOTH ACCESS ROADS AND THROUGH ROADS AS NECESSARY TO MAINTAIN BEST INTERFERE WITH TRAFFIC
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16. EXCAVATION SHALL BE DIVIDED IN BOTH ACCESS ROADS AND THROUGH ROADS AS NECESSARY TO MAINTAIN BEST INTERFERE WITH TRAFFIC
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